

MEETING DATE: 3/5/2024

ITEM NO: 13

DESK ITEM

DATE: March 5, 2024

TO: Mayor and Town Council

FROM: Laurel Prevetti, Town Manager

SUBJECT: Consider the Adoption of a Resolution Denying an Appeal of a Planning

Commission Decision that Approved the Demolition of an Existing Single-Family Residence and Construction of a New Single-Family Residence with Reduced Setbacks on a Non-Conforming Property Zoned R-1D. **Located at 212 Thurston Street.** APN 410-15-039. This Project is Categorically Exempt Pursuant to the California Environmental Quality Act (CEQA) Guidelines,

Section 15303(a): New Construction or Conversion of Small

Structures. PROPERTY OWNER/APPLICANT: Meleah Guillardo. PROJECT

PLANNER: Maria Chavarin

REMARKS:

Attachment 9 includes a supplemental letter and plans received from the applicant on March 5, 2024.

ATTACHMENTS:

Previously received with the March 5, 2024 Staff Report:

- 1. December 13, 2024 Planning Commission Staff Report
- 2. January 10, 2024 Planning Commission Staff Report, with Exhibits 1-12
- 3. January 10, 2024 Planning Commission Verbatim Minutes
- 4. January 17, 2024 Planning Commission Action Letter
- 5. Appeal of the Planning Commission Decision, received January 22, 2024
- 6. Applicant's Response to Appeal, Received February 20, 2024
- 7. Draft Resolution to Deny Appeal and Approve Project

Previously received with the March 5, 2024 Addendum Report:

8. Supplemental Appeal Letter, Received March 3, 2024

PREPARED BY: Maria Chavarin

Assistant Planner

Reviewed by: Town Manager, Assistant Town Manager, Town Attorney, and Community Development Director

PAGE **2** OF **2**

SUBJECT: 212 Thurston Street/S-23-009

DATE: March 5, 2024

ATTACHMENTS (continued):

Received with this Desk Item Report:

9. Suppledmental letter and plans, Received March 5, 2024

Meleah Guillardo 212 Thurston St. Los Gatos, CA 95030 408.364.6993

March 5, 2024

Dear Los Gatos Town Council Members,

I am providing responses to the appellant's most recent comments provided on March 3, 2024. I have provided responses to his previous letters dated January 22, 2024, July 12, 2023, and July 7, 2023.

"Error or abuse of discretion by the Planning Commission for the 'setback, condition of approval for existing garage to remain"

I would like to first highlight that the "Request for Approval for Demolition of an Existing Single-Family Residence and Construction of a New Single-Family Residence with Reduced Setbacks on a Non-Conforming Property Zoned R-1D" passed with the Planning Commission's vote of 5-1 on January 10, 2024. The Planning Commission is a competent group of individuals who spent extensive time evaluating the application, reviewing the various Town of Los Gatos department's comments (Building, Planning, Engineering, Architecture, Fire), reviewing public comments, and all Planning Commissioners even performed a neighborhood and site visit to substantiate their decision.

As stated in my previous response to the appellant and throughout the full planning process, there has never been an intent in my application to remove the existing garage, which has been in its current condition and location since 1915. As part of the January 10, 2024 Planning Commission meeting, I agreed to the added condition to repair the garage as part of my construction plans to appease my neighbors' concerns. The repair of the garage will include fixing the roof, gutters and drainage concerns the appellant raises, which is also the first time I'm hearing of this drainage concern from the appellant.

My garage is a legal, non-conforming structure. The appellant has cited the following Town Code section as his basis for requesting the movement of the garage:

1. Sec. 29.10.245 to 29.10.255 - These codes are related to the expansion of non-conforming buildings and do not apply to my existing garage, because I do not plan to enlarge or change the use of the garage. There are no plans for my garage beyond repair and therefore the setbacks under these codes do not apply.

Further the appellant cited the following codes that he believes the Planning Commissioners violated:

2. Sec. 29.20.150 - This code relates to considerations in the review of applications. The Planning Commissioners and various Town of Los Gatos departments thoroughly

- considered the various aspects of this code in their review and ultimately approved the application.
- 3. Sec. 29-20-160 to Sec.29.20.175 These codes are related to conditions of approval. As part of the January 10, 2024 Planning Commission meeting, I have agreed to the terms to repair my garage, which was added to appease my neighbors' concerns.

The appellant did not attend the January 10, 2024 Planning Commission meeting. At this meeting, not only was the condition of the garage discussed, but I also addressed that I planned to keep the garage in its current location. The Planning Commission added a condition for me to repair the garage concurrent with the construction of the new home to address the neighbors' concerns. Further, this condition was accepted by the neighbors' who attended this public meeting, which included the neighbors bordering 212 Thurston St. and whose property borders the garage (105 Olive St.).

The Planning Commission did not err or abuse their powers regarding the garage. The appellant's request to demolish and move the garage based on the lack of any code violation, is egregious and unreasonable. This would be a very expensive request on an already high cost project to satisfy the appellant's apparent main garage setback concern, drainage, which I've noted will be addressed when the garage is repaired. I have no intention of tearing down or moving this garage.

"Planning Commission's decision is not supported by substantial evidence in the record as 'setbacks do not conform to R1-D minimum setback requirements'"

The setbacks for the non-conforming lot were thoroughly discussed throughout the whole planning process and at the Planning Commision meeting on January 10, 2024. Again, I want to address the competency and thoroughness of procedures performed by the Planning Commission and Town of Los Gatos departments to ensure the setbacks were appropriate by code and conformed with the neighborhood. The Planning Commissioners performed a neighborhood and site visit to assess the setbacks and heights, to substantiate their approval of the plan on January 10, 2024.

The Planning Commission additionally asked my immediate neighbors who attending the Planning Commission meeting and who border my home on Olive St. (105, 103, and 101 Olive St.) for their concerns regarding the setbacks and even offered them various scenarios (move the house back to increase front setbacks, move the house forward and further reduce front setbacks, or lower the height of the house, all to address their privacy and sunlight concerns), but ultimately the neighbors determined that the current setbacks and heights best addressed any privacy and sunlight concerns and they did not raise any further concerns on January 10, 2024. The appellant had the opportunity, like my neighbors, to raise his concerns regarding the setbacks and height at the January 10, 2024 meeting, but the appellant did not attend the meeting nor raise any concerns on this date.

The Planning Commission voted in favor to approve the setbacks as they are. The Planning Commission did not err or abuse their powers regarding the setbacks or building height. The setbacks and height are appropriate for a non-conforming lot and the neighborhood, which includes multiple 2 story homes (including the appellant's) and non-conforming setbacks.


Additional concerns raised in the appellant's letter have also been previously raised and addressed during the planning process and at the Planning Commision meeting. One of my neighbors' main concerns is privacy, which is also one of my main concerns, as my bedroom and bathroom face into the Olive St. neighbors' yards. To address this privacy concern, I have agreed to adjust the heights of my windows, have frosted glass bathroom windows, and will plant privacy screening trees bordering the fences. To further address the privacy concerns, I have submitted landscape architecture plans to demonstrate the location and type of screening trees, English Laurel hedges, which are evergreen and drought tolerant. I will maintain these privacy screening trees and their heights to protect my neighbors' privacy concerns as well as my own. My neighbors also have the right to address any of their own privacy concerns on their own properties. I have further provided a "shadow study" (refer to page A1 of submitted plans) as part of my approved project plans, which did not indicate any significant sunlight impact for my neighbors. This study has been reviewed and approved as part of my application by the Planning Commission and Town of Los Gatos departments. As part of my planning application, I also submitted documentation that I met my surrounding neighbors in person and who were available (on Thurston St. Monterey Ave., and immediate neighbors on Olive St.) and I notified them of my project plans and none of them indicated strong concerns to my project. This neighbor visit included meeting the appellant's parents who are the primary occupants of 214 Thurston St., who also did not raise any concerns during my visit and were happy to see the existing home be torn down with new construction and did not mention any concerns about the garage. They also did not attend the January 10, 2024 Planning Commission meeting.

Town Council Members, I appreciate your time and consideration into my project and I hope that you will agree with the Planning Commission's approval. Please take into consideration the thoroughness and time the Planning Commission, various Los Gatos departments, and my team and myself have put into this project to ensure that it abides by the Town Codes and takes neighbors' concerns seriously. I am a first time home owner and I am grateful for the opportunity to build my dream home in this beautiful town that I grew up in and to be a good and compromising neighbor.

Sincerely,

Meleah Guillardo

This Page Intentionally Left Blank

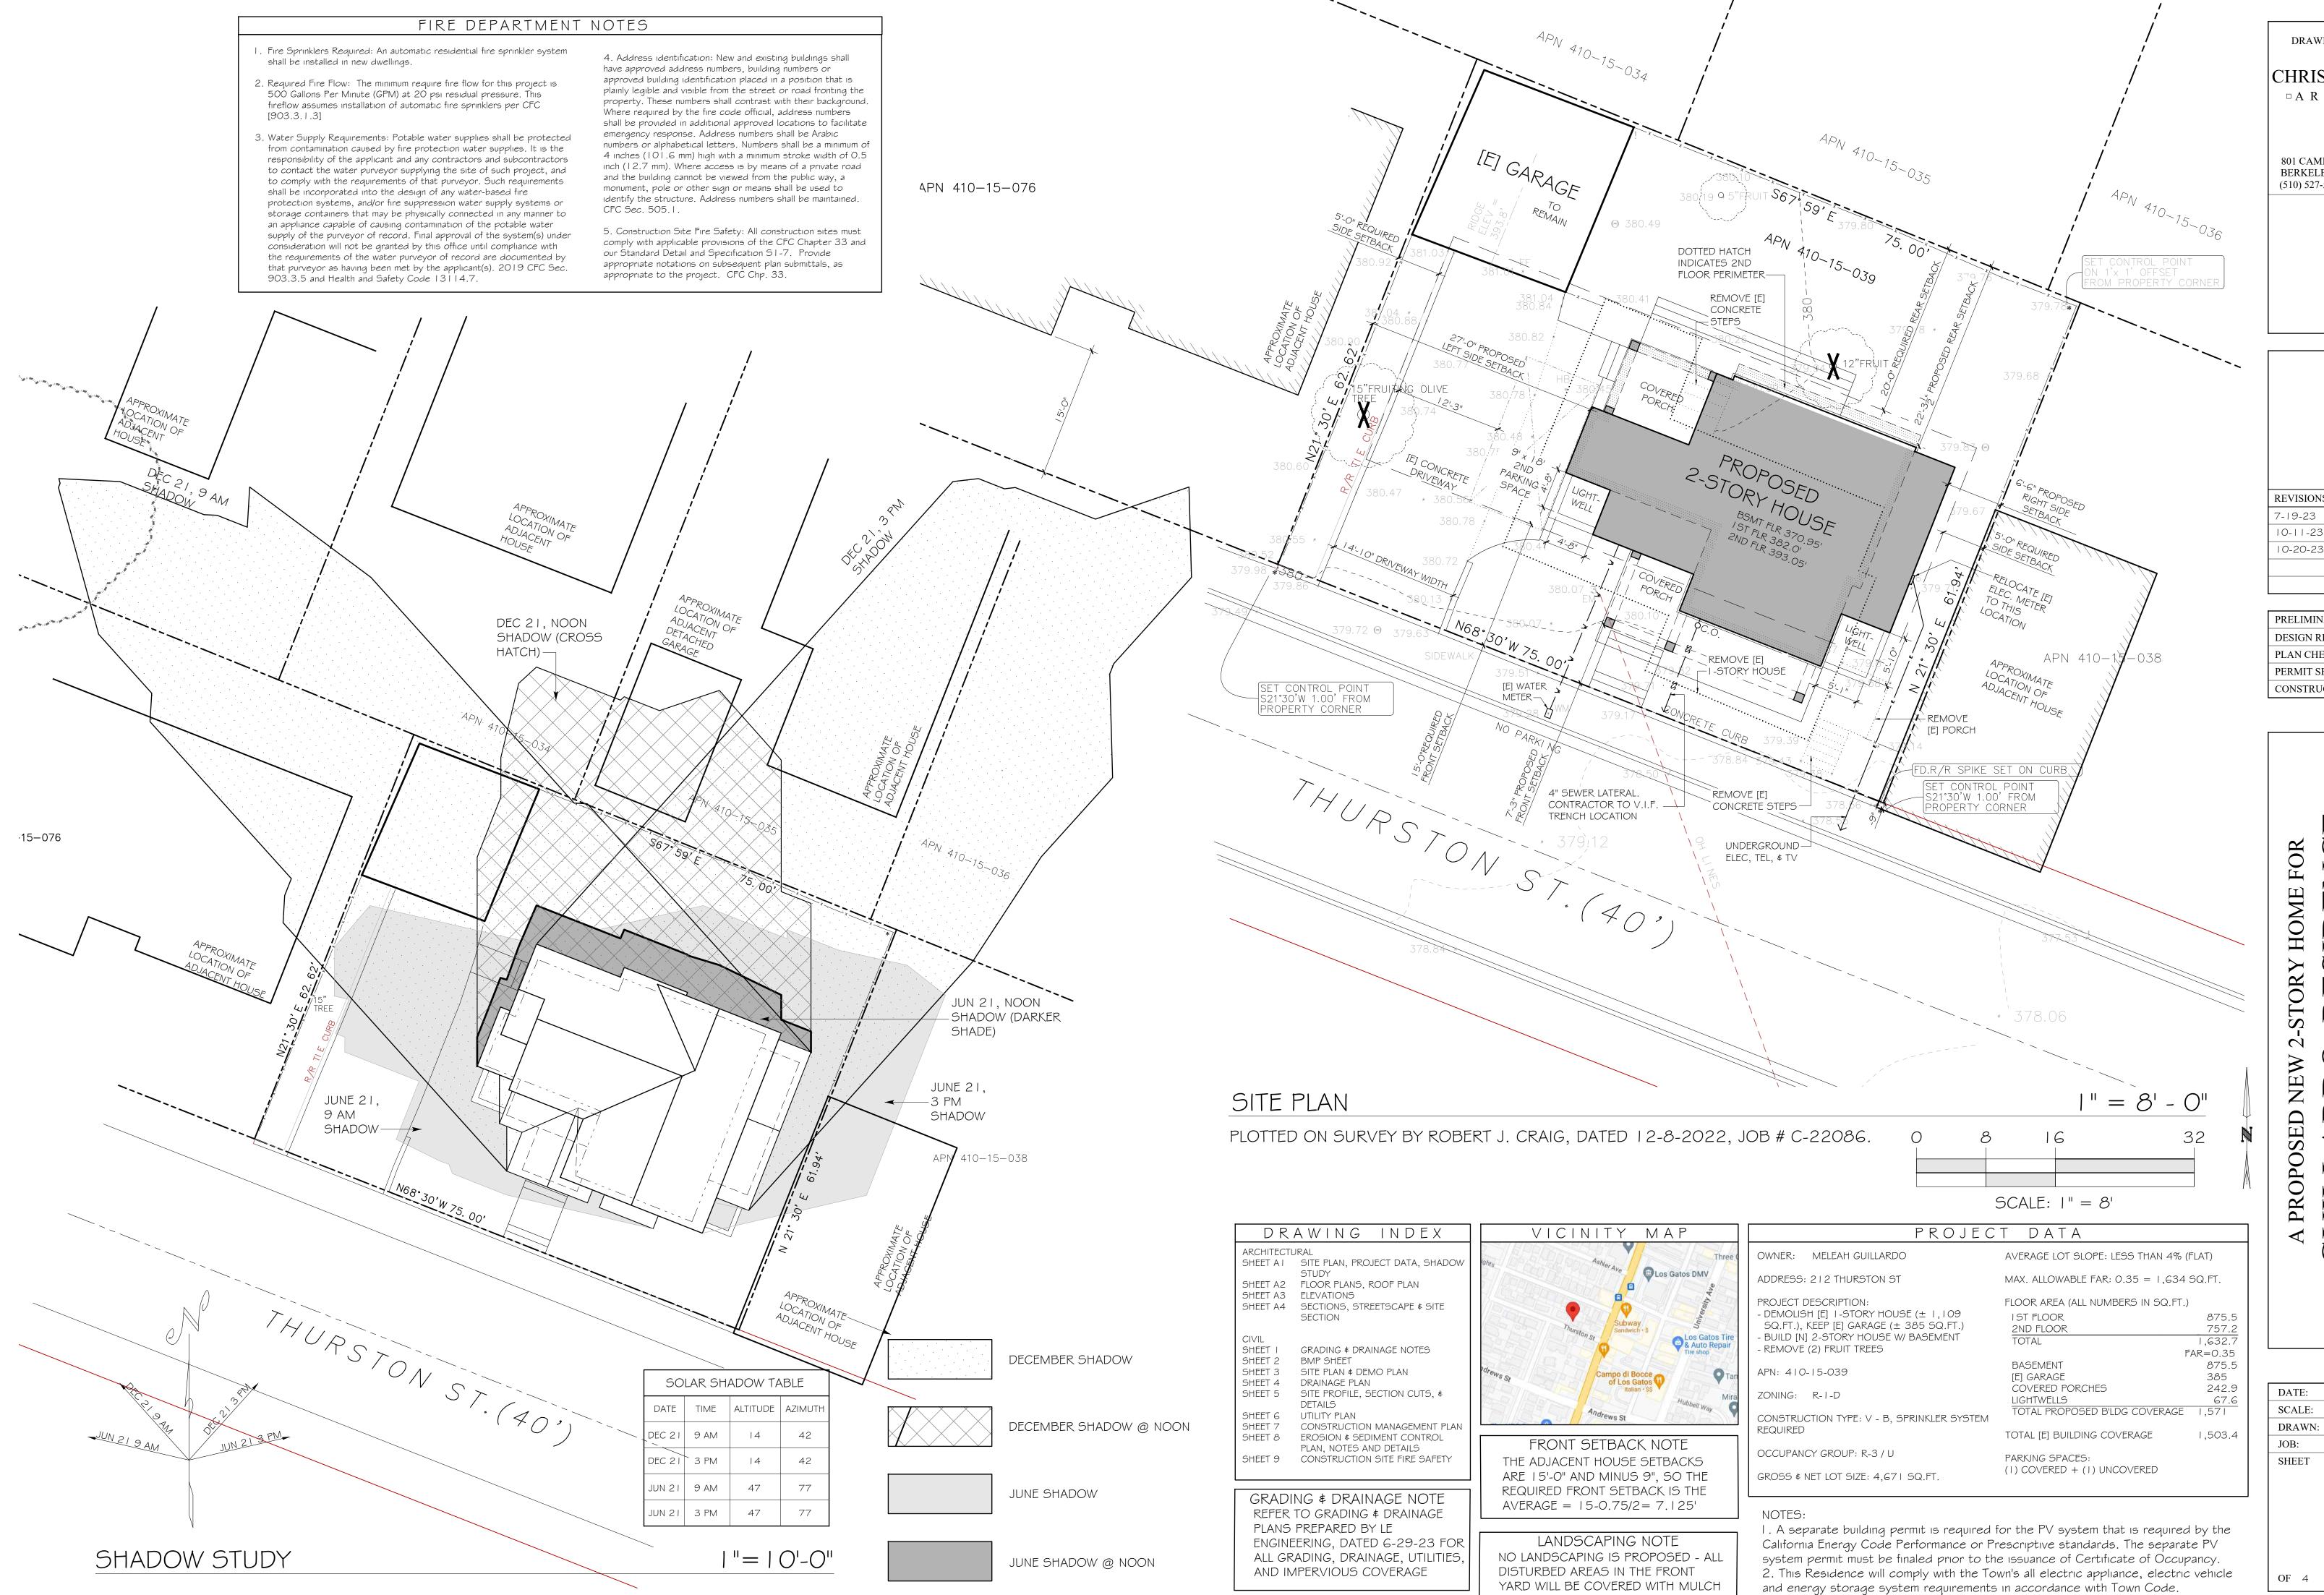

PRIOR TO FINAL INSPECTION

DRAWINGS PREPARED BY

801 CAMELIA STREET SUITE E BERKELEY CALIFORNIA 94710 (510) 527-5997 FAX (510) 527-5999

VISIONS	BY
19-23	db
)-11-23	
)-20-23	

PRELIMINARY SET	
DESIGN REVIEW SET	
PLAN CHECK SET	
PERMIT SET	
CONSTRUCTION SET	

HOME FOR IDENCE

A PROPOSED NEW 2-STORY HOME FOR GUILLARDO RESIDENCE 212 THURSTON ST

DATE: 4-17-23


SCALE: AS NOTED

DRAWN: CS/DB

JOB: GUILLARDO

SHEET

A1
SHEETS

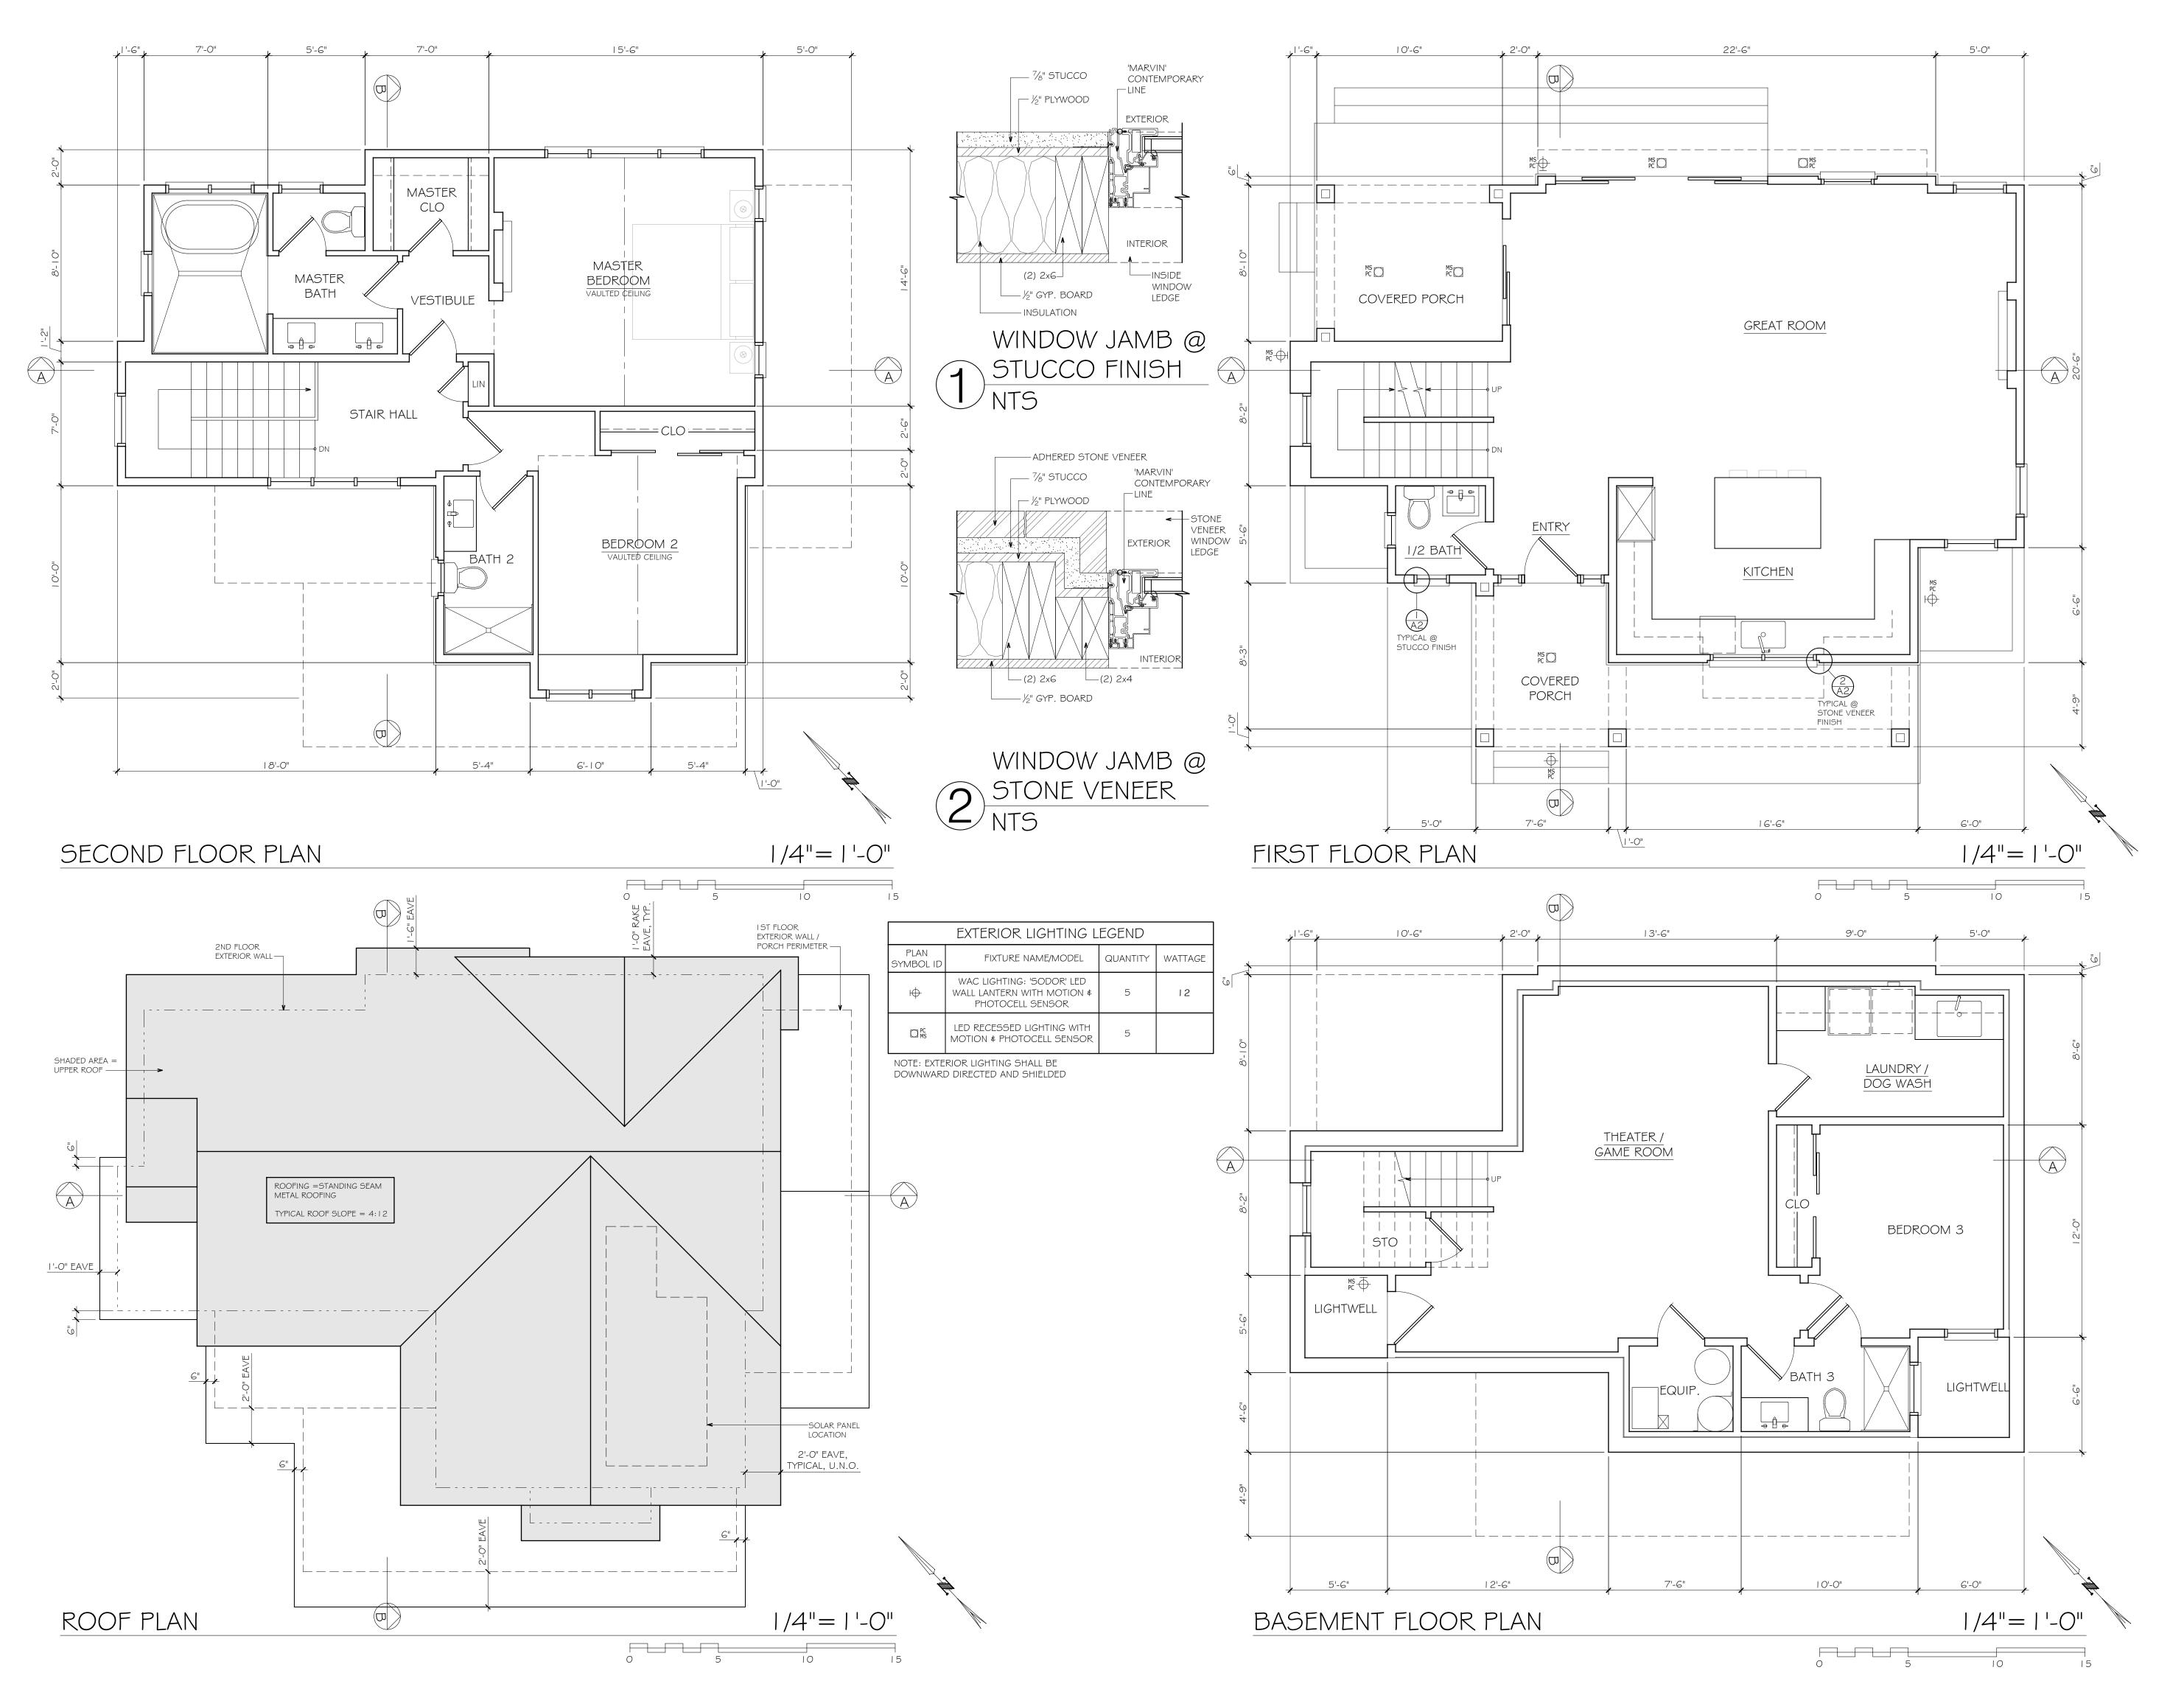

DRAWINGS PREPARED BY

CHRIS SPAULDING

-- A R C H I T E C T --

801 CAMELIA STREET SUITE E BERKELEY CALIFORNIA 94710 (510) 527-5997 FAX (510) 527-5999

REVISIONS BY
7-19-23 db
10-11-23
10-20-23

PRELIMINARY SET


DESIGN REVIEW SET

PLAN CHECK SET

PERMIT SET

CONSTRUCTION SET

A PROPOSED NEW 2-STORY HOME FOR GUILLARDO RESIDENCE 212 THURSTON ST LOS GATOS GALIFORNIA

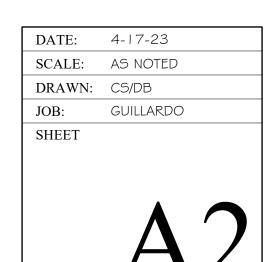

OF 4



DRAWINGS PREPARED BY

CHRIS SPAULDING

801 CAMELIA STREET SUITE E BERKELEY CALIFORNIA 94710 (510) 527-5997 FAX (510) 527-5999

REVISIONS BY
7-19-23 db
10-11-23
10-20-23

PRELIMINARY SET

DESIGN REVIEW SET

PLAN CHECK SET

PERMIT SET

CONSTRUCTION SET

A PROPOSED NEW 2-STORY HOME FOR GUILLARDO RESIDENCE
212 THURSTON ST
LOS GATOS - CALIFORNIA

DATE: 4-17-23

SCALE: AS NOTED


DRAWN: CS/DB

JOB: GUILLARDO

SHEET

A3


OF 4 SHEETS

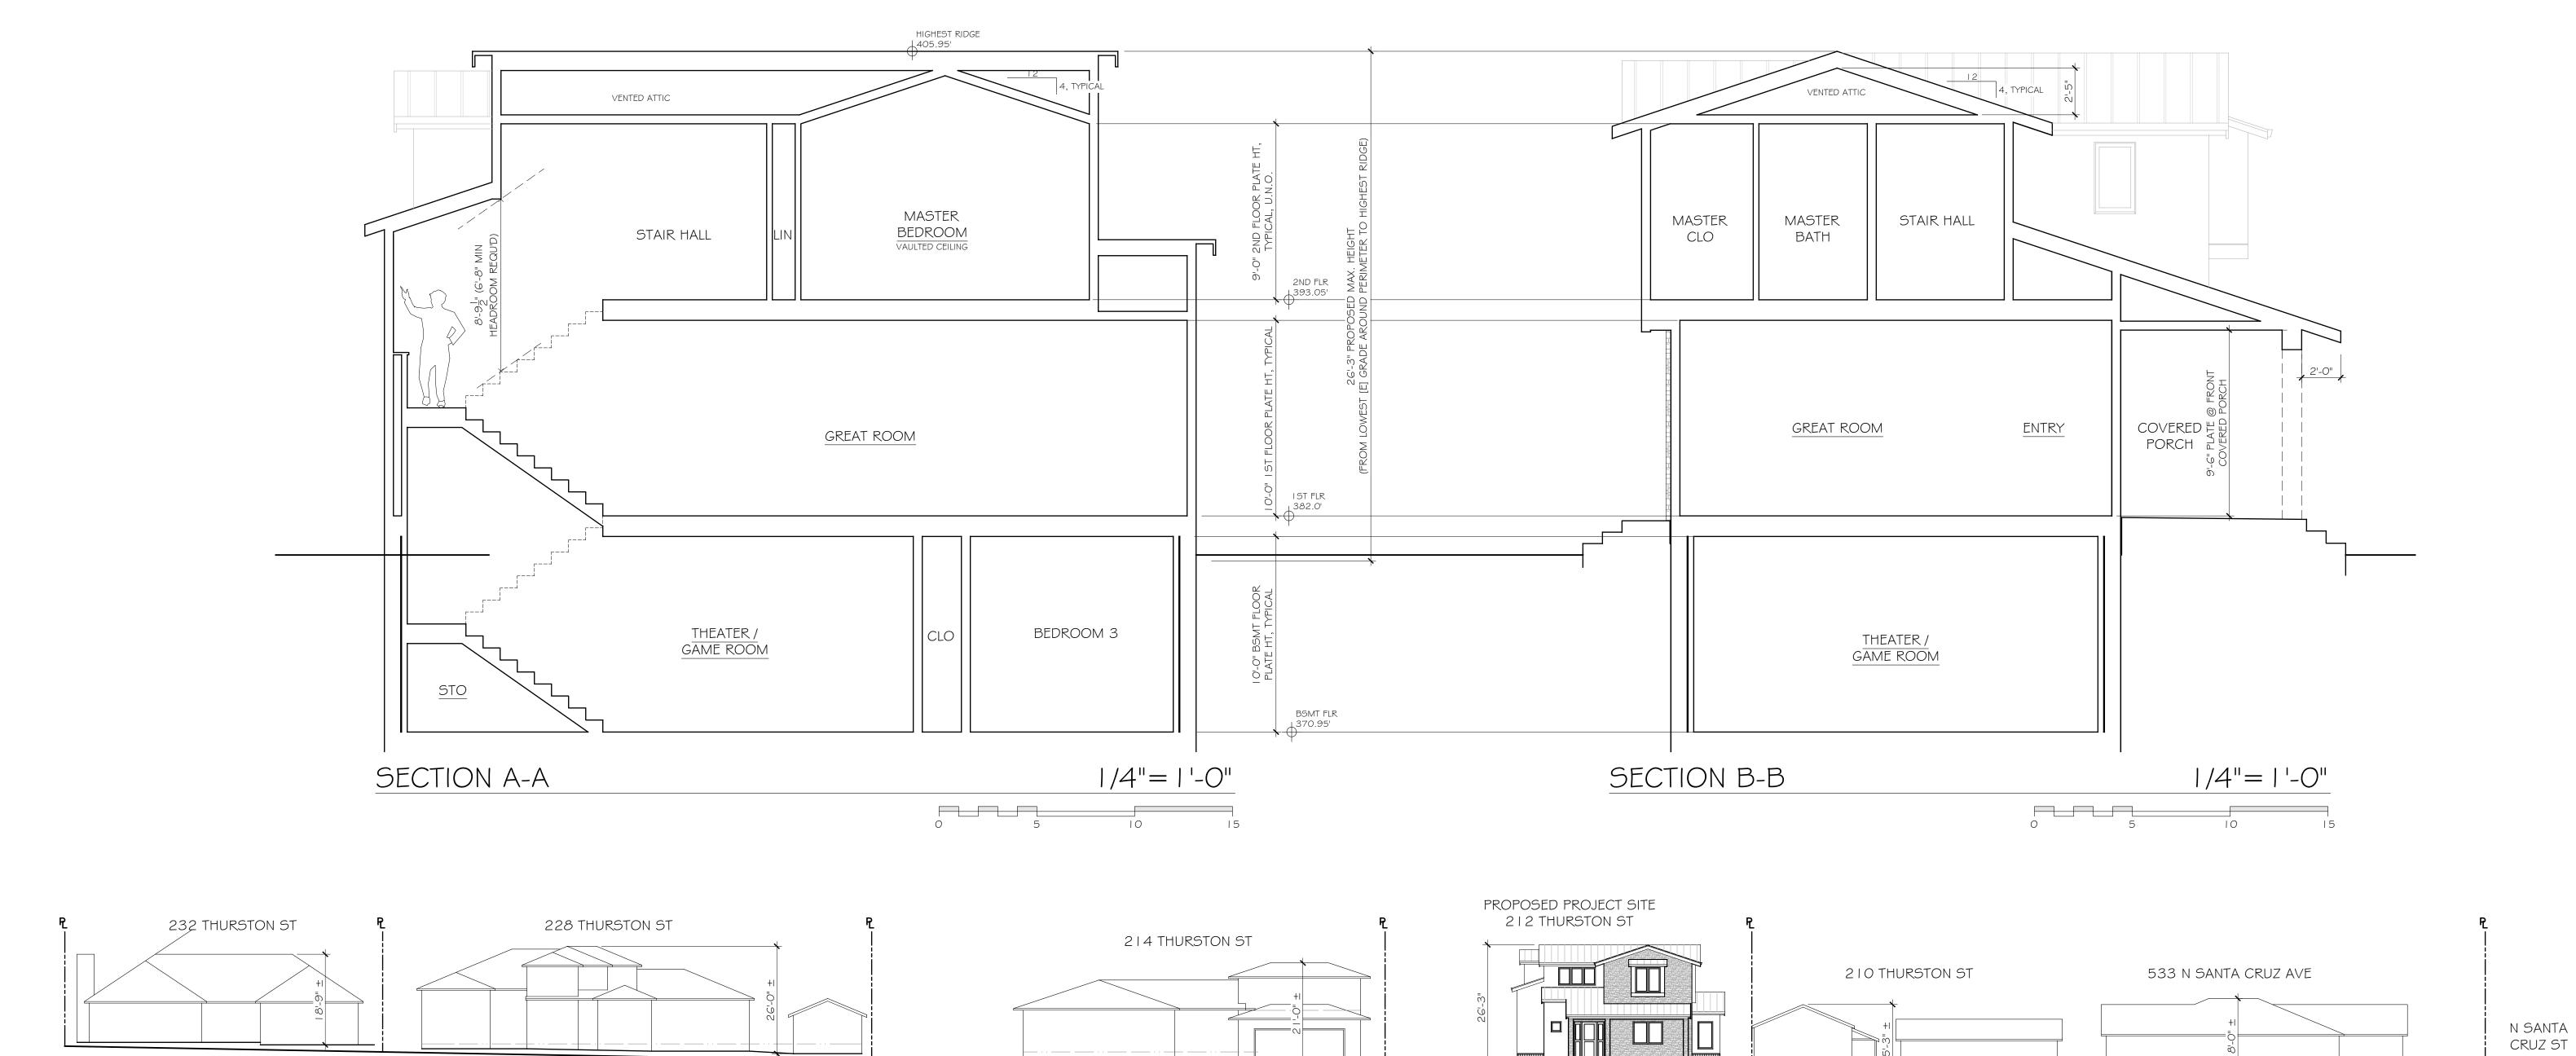



590 MONTEREY AVE

STREETSCAPE LOOKING TOWARDS PROJECT SITE

531 N SANTA CRUZ AVE

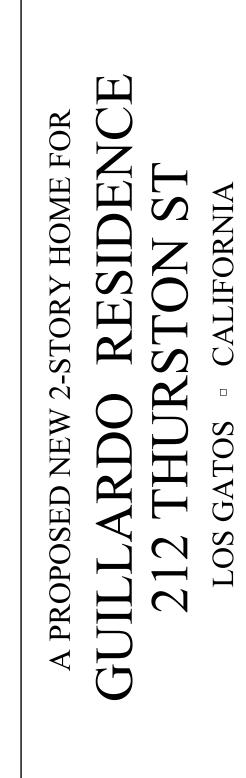

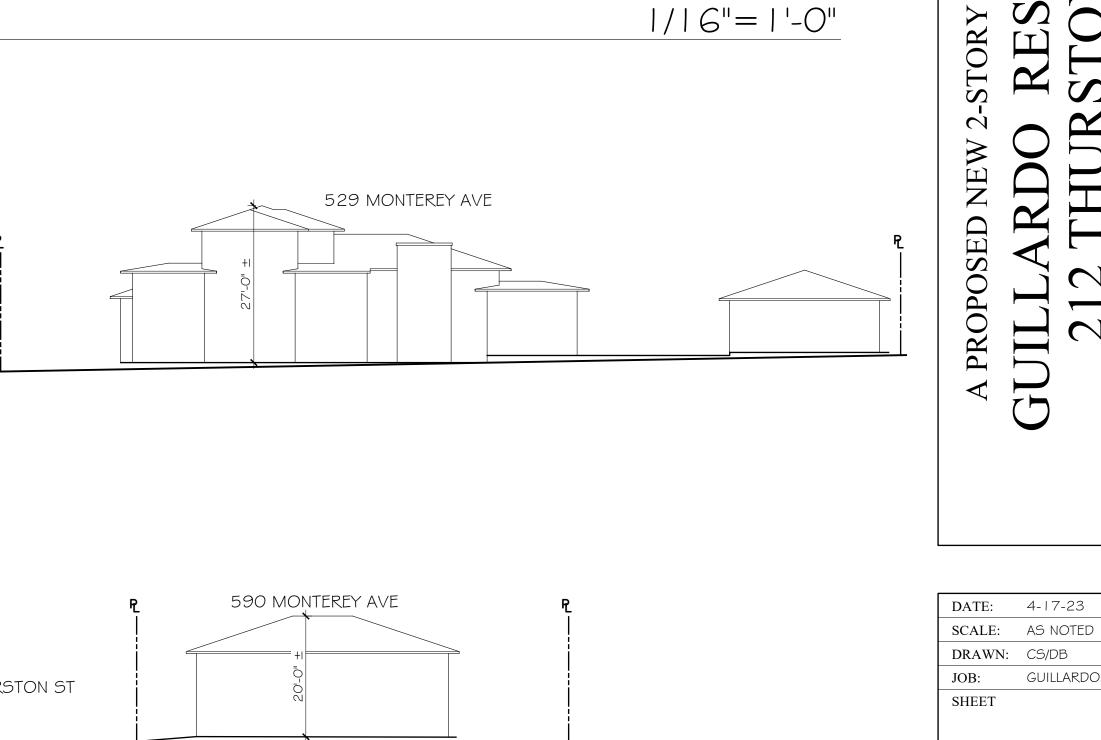

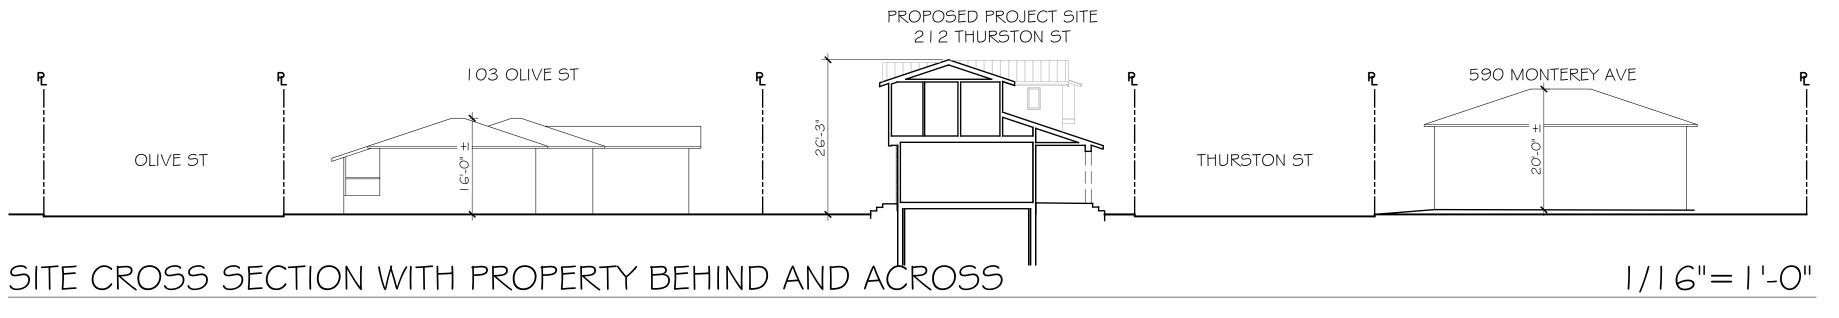

MONTEREY AVE

CHRIS SPAULDING \Box A R C H I T E C T \Box

DRAWINGS PREPARED BY

801 CAMELIA STREET SUITE E BERKELEY CALIFORNIA 94710 (510) 527-5997 FAX (510) 527-5999

REVISIONS 7-19-23 10-11-23 10-20-23

PRELIMINARY SET DESIGN REVIEW SET PLAN CHECK SET PERMIT SET CONSTRUCTION SET

SHEET

GUILLARDO

2. NO WORK MAY BE STARTED ON-SITE WITHOUT AN APPROVED GRADING PLAN AND A GRADING PERMIT ISSUED BY THE TOWN OF LOS GATOS, PARKS AND PUBLIC WORKS DEPARTMENT LOCATED AT 41 MILES AVENUE, LOS GATOS, CA 95030.

3. A PRE-JOB MEETING SHALL BE HELD WITH THE TOWN ENGINEERING INSPECTOR FROM THE PARKS AND PUBLIC WORKS DEPARTMENT PRIOR TO ANY WORK BEING DONE. THE CONTRACTOR SHALL CALL THE INSPECTIONS LINE AT (4080 399-5771 AT LEAST FORTY-EIGHT (48) HOURS PRIOR TO ANY GRADING OR ONSITE WORK. THIS MEETING SHOULD INCLUDE:

a. A DISCUSSION OF THE PROJECT CONDITIONS OF APPROVAL, WORKING HOURS, SITE MAINTENANCE AND OTHER CONSTRUCTION MATTERS;

b. ACKNOWLEDGEMENT IN WRITING THAT CONTRACTOR AND APPLICANT HAVE READ AND UNDERSTAND THE PROJECT CONDITIONS OF APPROVAL, AND WILL MAKE CERTAIN THAT ALL PROJECT SUB-CONTRACTORS HAVE READ AND UNDERSTAND THEM PRIOR TO COMMENCING WORK AND THAT A COPY OF THE PROJECT CONDITIONS OF APPROVAL WILL BE POSTED ON SITE AT ALL TIMES DURING

4. APPROVAL OF PLANS DOES NOT RELEASE THE DEVELOPER OF THE RESPONSIBILITY FOR THE CORRECTION OF MISTAKES. ERRORS. OR OMISSIONS CONTAINED THEREIN. IF. DURING THE COURSE OF CONSTRUCTION OF THE IMPROVEMENTS, PUBLIC INTEREST AND SAFETY REQUIRES A MODIFICATION OR DEPARTURE FROM THE TOWN SPECIFICATIONS OR THESE IMPROVEMENT PLANS. THE TOWN ENGINEER SHALL HAVE FULL AUTHORITY TO REQUIRE SUCH MODIFICATION OR DEPARTURE AND TO SPECIFY THE MANNER IN WHICH THE SAME IS TO BE MADE.

APPROVAL OF THIS PLAN APPLIES ONLY TO THE GRADING, EXCAVATION, PLACEMENT, AND COMPACTION OF NATURAL EARTH MATERIALS. THIS APPROVAL DOES NOT CONFER ANY RIGHTS OF ENTRY TO EITHER PUBLIC PROPERTY OR THE PRIVATE PROPERTY OF OTHERS AND DOES NOT CONSTITUTE APPROVAL OF ANY OTHER IMPROVEMENTS.

6. EXCAVATED MATERIAL SHALL BE PLACED IN THE FILL AREAS DESIGNATED OR SHALL BE HAULED AWAY FROM THE SITE TO BE DISPOSED OF AT APPROVED LOCATION(S).

7. IT SHALL BE THE RESPONSIBILITY OF THE PERMITTEE OR CONTRACTOR TO IDENTIFY, LOCATE AND PROTECT ALL UNDERGROUND FACILITIES. PERMITTEE OR CONTRACTOR SHALL NOTIFY USA (UNDERGROUND SERVICE ALERT) AT 1-800-227-2600 A MINIMUM OF FORTY-EIGHT (48) HOURS BUT NOT MORE THAN FOURTEEN (14) DAYS PRIOR TO COMMENCING ALL WORK.

8. ALL GRADING SHALL BE PERFORMED IN SUCH A MANNER AS TO COMPLY WITH THE STANDARDS ESTABLISHED BY THE AIR QUALITY MANAGEMENT DISTRICT FOR AIRBORNE PARTICULATES.

9. THE CONTRACTOR SHALL COMPLY WITH ALL LOCAL, STATE AND FEDERAL LAWS, CODES, RULES AND REGULATIONS GOVERNING THE WORK IDENTIFIED ON THESE PLANS. THESE SHALL INCLUDE, WITHOUT LIMITATION, SAFETY AND HEALTH RULES AND REGULATIONS ESTABLISHED BY OR PURSUANT TO THE OCCUPATIONAL SAFETY AND HEALTH ACT OR ANY OTHER APPLICABLE PUBLIC AUTHORITY.

10. THE GENERAL CONTRACTOR SHALL PROVIDE QUALIFIED SUPERVISION ON THE JOB SITE AT ALL TIMES DURING CONSTRUCTION.

11. HORIZONTAL AND VERTICAL CONTROLS SHALL BE SET AND CERTIFIED BY A LICENSED SURVEYOR OR REGISTERED CIVIL ENGINEER QUALIFIED TO PRACTICE LAND SURVEYING, FOR THE FOLLOWING ITEMS:

a. RETAINING WALL: TOP OF WALL ELEVATIONS AND LOCATIONS (ALL WALLS TO BE PERMITTED SEPARATELY AND APPLIED FOR AT THE TOWN OF LOS GATOS

b. TOE AND TOP OF CUT AND FILL SLOPES.

12. PRIOR TO ISSUANCE OF ANY PERMIT, THE APPLICANT'S SOILS ENGINEER SHALL REVIEW THE FINAL GRADING AND DRAINAGE PLANS TO ENSURE THAT DESIGNS FOR FOUNDATIONS, RETAINING WALLS, SITE GRADING, AND SITE DRAINAGE ARE IN ACCORDANCE WITH THEIR RECOMMENDATIONS AND THE PEER REVIEW COMMENTS. THE APPLICANT'S SOILS ENGINEER'S APPROVAL SHALL THEN BE CONVEYED TO THE TOWN EITHER BY LETTER OR BY SIGNING THE PLANS. SOILS ENGINEER POLLAK ENGINEERING, INC

_____, DATED 22 JUNE, 2023 REFERENCE REPORT NO. 1047 __, DATED __ THOROUGHLY COMPLIED WITH. BOTH THE MENTIONED REPORT AND ALL UPDATES/ADDENDUMS/LETTERS ARE HEREBY APPENDED AND MADE A PART OF THIS

13. DURING CONSTRUCTION, ALL EXCAVATIONS AND GRADING SHALL BE INSPECTED BY THE APPLICANT'S SOILS ENGINEER. THE ENGINEER SHALL BE NOTIFIED AT LEAST FORTY—EIGHT (48) HOURS BEFORE BEGINNING ANY GRADING. THE ENGINEER SHALL BE ON-SITE TO VERIFY THAT THE ACTUAL CONDITIONS ARE AS ANTICIPATED IN THE DESIGN-LEVEL GEOTECHNICAL REPORT AND/OR PROVIDE APPROPRIATE CHANGES TO THE REPORT RECOMMENDATIONS, AS NECESSARY. ALL UNOBSERVED AND/OR UNAPPROVED GRADING SHALL BE REMOVED AND REPLACED UNDER SOILS ENGINEER OBSERVANCE (THE TOWN INSPECTOR SHALL BE MADE AWARE OF ANY REQUIRED CHANGES PRIOR TO WORK BEING PERFORMED).

14. THE RESULTS OF THE CONSTRUCTION OBSERVATION AND TESTING SHOULD BE DOCUMENTED IN AN "AS-BUILT" LETTER/REPORT PREPARED BY THE APPLICANTS' SOILS ENGINEER AND SUBMITTED FOR THE TOWN'S REVIEW AND ACCEPTANCE BEFORE FINAL RELEASE OF ANY OCCUPANCY PERMIT IS GRANTED.

15. ALL PRIVATE AND PUBLIC STREETS ACCESSING PROJECT SITE SHALL BE KEPT OPEN AND IN A SAFE, DRIVABLE CONDITION THROUGHOUT CONSTRUCTION. IF TEMPORARY CLOSURE IS NEEDED, THEN FORMAL WRITTEN NOTICE TO THE ADJACENT NEIGHBORS AND THE TOWN OF LOS GATOS PARKS AND PUBLIC WORKS DEPARTMENT SHALL BE PROVIDED AT LEAST ONE (1) WEEK IN ADVANCE OF CLOSURE AND NO CLOSURE SHALL BE GRANTED WITHOUT THE EXPRESS WRITTEN APPROVAL OF THE TOWN. NO MATERIAL OR EQUIPMENT SHALL BE STORED IN THE PUBLIC OR PRIVATE RIGHT-OF-WAY.

16. THE CONTRACTOR SHALL INSTALL AND MAINTAIN FENCES, BARRIERS, LIGHTS AND SIGNS THAT ARE NECESSARY TO GIVE ADEQUATE WARNING AND/PROTECTION TO THE PUBLIC AT ALL TIMES.

17.	OWNER/APPLICANT:	MELEAH GUILLARDO	PHONE:	
18.	GENERAL CONTRACTOR:_		PHONE:	
19.	GRADING CONTRACTOR:		_PHONE:	

21. WATER SHALL BE AVAILABLE ON THE SITE AT ALL TIMES DURING GRADING OPERATIONS TO PROPERLY MAINTAIN DUST CONTROL.

22. THIS PLAN DOES NOT APPROVE THE REMOVAL OF TREES. APPROPRIATE TREE REMOVAL PERMITS AND METHODS OF TREE PRESERVATION SHALL BE REQUIRED. TREE REMOVAL PERMITS ARE REQUIRED PRIOR TO THE APPROVAL OF ALL PLANS.

23. A TOWN ENCROACHMENT PERMIT IS REQUIRED FOR ANY WORK WITHIN THE PUBLIC RIGHT-OF-WAY. A STATE ENCROACHMENT PERMIT IS REQUIRED FOR ANY WORK WITHIN STATE RIGHT-OF-WAY (IF APPLICABLE). THE PERMITTEE AND/OR CONTRACTOR SHALL BE RESPONSIBLE COORDINATING INSPECTION PERFORMED BY OTHER GOVERNMENTAL AGENCIES.

24. NO CROSS-LOT DRAINAGE WILL BE PERMITTED WITHOUT SATISFACTORY STORMWATER ACCEPTANCE DEED/FACILITIES. ALL DRAINAGE SHALL BE DIRECTED TO THE STREET OR OTHER ACCEPTABLE DRAINAGE FACILITY VIA A NON-EROSIVE METHOD AS APPROVED BY THE TOWN ENGINEER.

25. IT IS THE RESPONSIBILITY OF CONTRACTOR AND/OR OWNER TO MAKE SURE THAT ALL DIRT TRACKED INTO THE PUBLIC RIGHT-OF-WAY IS CLEANED UP ON A DAILY BASIS. MUD, SILT, CONCRETE AND OTHER CONSTRUCTION DEBRIS SHALL NOT BE WASHED INTO THE TOWN'S STORM DRAINS.

26. GOOD HOUSEKEEPING PRACTICES SHALL BE OBSERVED AT ALL TIMES DURING THE COURSE OF CONSTRUCTION. SUPERINTENDENCE OF CONSTRUCTION SHALL BE DILIGENTLY PERFORMED BY A PERSON OR PERSONS AUTHORIZED TO DO SO AT ALL TIMES DURING WORKING HOURS. THE STORING OF GOODS AND/OR MATERIALS ON THE SIDEWALK AND/OR THE STREET WILL NOT BE ALLOWED UNLESS A SPECIAL PERMIT IS ISSUED BY THE ENGINEERING DIVISION. THE ADJACENT PUBLIC RIGHT-OF-WAY SHALL BE KEPT CLEAR OF ALL JOB RELATED DIRT AND DEBRIS AT THE END OF THE DAY. FAILURE TO MAINTAIN THE PUBLIC RIGHT-OF-WAY. ACCORDING TO THIS CONDITION MAY RESULT IN PENALTIES AND/OR THE TOWN PERFORMING THE REQUIRED MAINTENANCE AT THE DEVELOPER'S EXPENSE.

27. GRADING SHALL BE UNDERTAKEN IN ACCORDANCE WITH CONDITIONS AND REQUIREMENTS OF THE PROJECT STORM WATER POLLUTION CONTROL PLAN AND/OR STORM WATER POLLUTION PREVENTION PLAN (SWPPP), THE TOWN OF LOS GATOS STORM WATER QUALITY MANAGEMENT PROGRAM, NATIONAL POLLUTANT DISCHARGE ELIMINATION SYSTEM (NPDES) AND ANY OTHER PERMITS/REQUIREMENTS ISSUED BY THE STATE OF CALIFORNIA REGIONAL WATER QUALITY CONTROL BOARD. PLANS (INCLUDING ALL UPDATES) SHALL BE ON-SITE AT ALL TIMES. NO DIRECT STORMWATER DISCHARGES FROM THE DEVELOPMENT WILL BE ALLOWED ONTO TOWN STREETS OR INTO THE PUBLIC STORM DRAIN SYSTEM WITHOUT TREATMENT BY AN APPROVED STORM WATER POLLUTION PREVENTION DEVICE OR OTHER APPROVED METHODS. MAINTENANCE OF PRIVATE STORMWATER POLLUTION PREVENTION DEVICES SHALL BE THE SOLE RESPONSIBILITY OF THE OWNER. DISCHARGES OR CONNECTION WITHOUT TREATMENT BY AN APPROVED AND ADEQUATELY OPERATING STORMWATER POLLUTION PREVENTION DEVICE OR OTHER APPROVED METHOD SHALL BE CONSIDERED A VIOLATION OF THE ABOVE REFERENCED PERMIT AND THE TOWN OF LOS GATOS STORMWATER ORDINANCE.

TOWN OF LOS GATOS NPDES NOTES

SEDIMENT FROM AREAS DISTURBED BY CONSTRUCTION SHALL BE RETAINED ON SITE USING STRUCTURAL CONTROLS AS REQUIRED BY THE STATEWIDE GENERAL CONSTRUCTION STORMWATER PERMIT.

2. STOCKPILES OF SOIL SHALL BE PROPERLY CONTAINED TO MINIMIZE SEDIMENT TRANSPORT FROM THE SITE TO STREETS, DRAINAGE FACILITIES OR ADJACENT PROPERTIES VIA RUNOFF. VEHICLE TRACKING. OR WIND AS REQUIRED BY THE STATEWIDE GENERAL CONSTRUCTION STORMWATER PERMIT.

APPROPRIATE BEST MANAGEMENT PRACTICES (BMPS) FOR CONSTRUCTION—RELATED MATERIALS. WASTES. SPILL OR RESIDES SHALL BE IMPLEMENTED TO MINIMIZE TRANSPORT FROM THE SITE TO STREETS, DRAINAGE FACILITIES, OR ADJOINING PROPERTY BY WIND OR RUNOFF AS REQUIRED BY THE STATEWIDE GENERAL CONSTRUCTION STORMWATER PERMIT.

4. RUNOFF FROM EQUIPMENT AND VEHICLE WASHING SHALL BE CONTAINED AT CONSTRUCTION SITES AND MUST NOT BE DISCHARGED TO RECEIVING WATERS OR TO THE LOCAL STORM DRAIN SYSTEM.

5. ALL CONSTRUCTION CONTRACTOR AND SUBCONTRACTOR PERSONNEL ARE TO BE MADE AWARE OF THE REQUIRED BEST MANAGEMENT PRACTICES (BMPS) AND GOOD HOUSEKEEPING MEASURES FOR THE PROJECT SITE AND ANY ASSOCIATED CONSTRUCTION STAGING AREAS.

6. AT THE END OF EACH DAY OF CONSTRUCTION ACTIVITY, ALL CONSTRUCTION DEBRIS AND WASTE MATERIALS SHALL BE COLLECTED AND PROPERLY DISPOSED IN TRASH OR RECYCLE BINS.

7. CONSTRUCTION SITES SHALL BE MAINTAINED IN SUCH A CONDITION THAT A STORM DOES NOT CARRY WASTE OR POLLUTANTS OFF OF THE SITE. DISCHARGES OF MATERIAL OTHER THAN STORMWATER (NON-STORMWATER DISCHARGES) ARE PROHIBITED EXCEPT AS AUTHORIZED BY AN INDIVIDUAL NATIONAL POLLUTANT DISCHARGE ELIMINATION SYSTEM (NPDES) PERMIT OR THE STATEWIDE GENERAL CONSTRUCTION STORMWATER PERMIT. POTENTIAL POLLUTANTS INCLUDE BUT ARE NOT LIMITED TO: SOLID OR LIQUID CHEMICAL SPILLS; WASTES FROM PAINTS, STAINS, SEALANTS, SOLVENTS, DETERGENTS, GLUES, LIME, PESTICIDES, HERBICIDES, FERTILIZERS, WOOD PRESERVATIVES AND ASBESTOS FIBERS, PAINT FLAKES OR STUCCO FRAGMENTS; FUELS, OILS, LUBRICANTS, AND HYDRAULIC, RADIATOR OR BATTERY FLUIDS; CONCRETE AND RELATED CUTTING OR CURING RESIDUES; FLOATABLE WASTES; WASTES FROM ENGINE/EQUIPMENT STEAM CLEANING OR CHEMICAL DEGREASING; WASTES FROM STREET CLEANING; AND SUPERCHLORINATED POTABLE WATER FROM LINE FLUSHING AND TESTING. DURING CONSTRUCTION, DISPOSAL OF SUCH MATERIALS SHOULD OCCUR IN A SPECIFIED AND CONTROLLED TEMPORARY AREA ON-SITE PHYSICALLY SEPARATED FROM POTENTIAL STORMWATER RUNOFF, WITH ULTIMATE DISPOSAL IN ACCORDANCE WITH LOCAL, STATE AND FEDERAL REQUIREMENTS.

B. DISCHARGING CONTAMINATED GROUNDWATER PRODUCED BY DEWATERING GROUNDWATER THAT HAS INFILTRATED INTO THE CONSTRUCTION SITE IS PROHIBITED. DISCHARGING OF CONTAMINATED SOILS VIA SURFACE EROSION IS ALSO PROHIBITED. DISCHARGING NON-CONTAMINATED GROUNDWATER PRODUCED BY DEWATERING ACTIVITIES REQUIRES A NATIONAL POLLUTANT DISCHARGE ELIMINATION SYSTEM (NPDES) PERMIT FROM THE RESPECTIVE STATE REGIONAL WATER QUALITY CONTROL

MANHOLE

BOOK OF MAPS AT PAGE

GRADING AND DRAINAGE PLANS

212 THURSTON STREET, LOS GATOS, CA 95030 GRADING PERMIT APPLICATION NO. ASSESSOR'S PARCEL NO. 410-15-039

	P	ROJECT DATA
1	PROJECT ADDRESS:	212 THURSTON STREET, LOS GATOS, CA 95030
2	PROJECT OWNER:	MELEAH GUILLARDO
3	ASSESSORS PARCEL NUMBER:	410-15-039
4	EXISTING USE:	RESIDENTIAL
5	EXISTING ZONING:	R-1-D
6	PROPOSED USE:	RESIDENTIAL
7	PROPOSED ZONING:	R-1-D
8	SITE AREA:	0.1 ACRES MORE OR LESS
9	APPLICANT/DEVELOPER:	MELEAH GUILLARDO
10	CONSULTANTS:	
	A. ARCHITECT:	CHRIS SPAULDING ARCHITECT 801 CAMELIA STREET, SUITE E BERKELEY, CA 94710 TEL: (510) 527-5997
	B. SOIL ENGINEERING:	
	C. SURVEYOR:	ROBERT J. CRAIG LICENSED LAND SURVEYOR 966 ELSIE MAE DRIVE, BOULDER CREEK, CA 95006 TEL: (831) 359-1750
	D. CIVIL ENGINEER:	LC ENGINEERING 598 E. SANTA CLARA ST, #270 SAN JOSE, CA 95112 TEL: (408) 806-7187
11	WATER SUPPLY:	SAN JOSE WATER COMPANY
12	SANITARY SEWER DISPOSAL:	WEST VALLEY SANITATION DISTRICT (WVSD)
13	GAS AND ELECTRIC:	PACIFIC GAS AND ELECTRIC
14	TELEPHONE:	
15	CABLE:	
16	STORM DRAIN:	WEST VALLEY CLEAN WATER PROGRAM
17	FIRE PROTECTION:	SANTA CLARA COUNTY CENTRAL FIRE PROTECTION DISTRICT
18	DATUM:	ELEVATIONS SHOWN ON THIS MAP ARE BASED ON THE TOWN OF LOS GATOS BENCHMARK "LG 31". ELEVATION = 367.04', NGVD 29
19	BENCHMARK INFORMATION	PROJECT VERTICAL DATUM IS BASED ON NGVD 29
20	BASIS OF BEARINGS	THE BEARINGS SHOWN ON THIS MAP ARE BASED ON AVERAGING CURB LINES ALONG THURSTON STREET AND HOLDING THE BEARING OF N68°30'W AS SHOWN ON THE MAP OF THE NOTT SUBDIVISION FILED IN BOOK"D" OF MAPS,PAGE 9,SANTA CLARA COUNTY RECORDS.

ABBREVIATIONS

۸۵		MIN	AAINIIAAI IAA
AB	AGGREGATE BASE		MINIMUM
AC	ASPHALT CONCRETE	N&S	NAIL AND SILVER
AD	AREA DRAIN	NTS	NOT TO SCALE
ΑE	ANCHOR EASEMENT	ОН	OVERHEAD
BB	BUBBLER BOX	OG	ORIGINAL GROUND
BLDG	BUILDING	0S	OFFSET
	BUILDING SETBACK LINE	P	PAVEMENT FINISH GRADE
BW	BACK OF WALK	PA	PATIO
BWL		PAD	PAD ELEVATION
	CABLE TELEVISION	FDC	FIRE DEPARTMENT CONNECTION
	COBBLE ROCK ENERGY DISSIPATOR	P	PROPERTY LINE
CG	CURB & GUTTER	PFF	PEDESTRIAN EQUESTRIAN EA
	CENTERLINE		PERFORATED
CLF	CHAIN LINK FENCE		PARCEL MAP
	SANITARY SEWER CLEANOUT		POWER POLE PROP PROPOSE
	CURB OPENING		PRIVATE STORM DRAINAGE EA
	CONCRETE		PUBLIC SERVICE EASEMENT
	COUNTY STANDARD DETAIL		PUBLIC UTILITY EASEMENT
DE	DRAINAGE EMITTER	PVMT	PAVEMENT
DI	DRAINAGE INLET	PVC	POLYVINYL CHLORIDE
	DOCUMENT	R	RADIUS
	DOWNSPOUT	RW	
	DRIVEWAY	RE	
	EASEMENT		
		REM	
	ELEVATION	R/W	
LМ	ELECTRIC METER	SB	SETBACK
E(OH)	ELECTRIC OVERHEAD ELECTRIC UNDERGROUND EDGE OF PAVEMENT	SD	STORM DRAIN
F(UG)	FLECTRIC UNDERGROUND	SDE	STORM DRAIN EASEMENT
EP	EDGE OF PAVEMENT	SF	SLOPE FASEMENT
EV	ELECTRIC VAULT	SS SSE	SANITARY SEWER/LATERAL
	EXISTING	SSE SSE	SANITARY SEWER EASEMENT
EX FC	FACE OF CURB	STA	STATION
r C			
FD	FOUND	STD	STANDARD DETAIL
FF	FINISH ELEVATION OF SUBFLOOR	SW	SIDEWALK
FG	GROUND FINISH GRADE	TOB	TOP OF BANK
FH	FIRE HYDRANT	TC	TOP OF CURB
恒	FLOW LINE	TEMP	TEMPORARY
ĒМ	FORCED MAIN	TOC	TOP OF COVER
FS	FIRE SERVICE	TOE	TOE OF BANK
FT	FEET	TG	TOP OF GRATE
		TPF	TREE PROTECTION FENCE
G	GARAGE SLAB ELEVATION/GAS LINE	TW	TOP OF WALL
GPE	GENERAL PUBLIC EASEMENT		
GSB	GRADING SETBACK	TYP	TYPICAL
GM	GAS METER	UE	UTILITY EASEMENT
HP	HI POINT	VG	VALLEY GUTTER
IEE	INGRESS/EGRESS EASEMENT	W	WATER
INV	INVERT	WCE	WIRE CLEARANCE EASEMENT
IP	IRON PIPE	WE	WATER EASEMENT
		WLK	WALKWAY
JP	JOINT POLE	WM	WATER METER
LIP	LIP OF GUTTER	WOE	WATER METER WIRE OVERHANG EASEMENT
LRDA	LEAST RESTRICTIVE		
	DEVELOPMENT AREA	WV	WATER VALVE
LS	LANDSCAPED AREA	WVSD	WEST VALLEY SANITATION DIS
MAX	MAXIMUM		OF SANTA CLARA COUNTY

AVERAGE SLOPE

AVERAGE SLOPE LESS THAN 4%

SCOPE OF WORK

1. GRADE HOUSE SITE WITH A BASEMENT 2. SEED/LANDSCAPE ALL DISTURBED AREAS

SHEET INDEX

1. TOWN NOTES, GENERAL NOTES, LEGEND & ABBREVIATIONS

- 2. BLUEPRINT FOR A CLEAN BAY SHEET
- 3. DEMOLITION PLAN & SITE PLAN
- 4. GRADING AND DRAINAGE PLAN
- 5. BUILDING CROSS SECTIONS
- 6. UTILITY PLAN 7. EROSION CONTROL PLAN
- 8. EROSION CONTROL DETAILS
- 9. CONSTRUCTION MANAGEMENT PLAN

TREE/SHRUB

CONTOUR LINES

RETAINING WALL

✓ SECTION NUMBER

(**1** / ← SHEET NUMBER

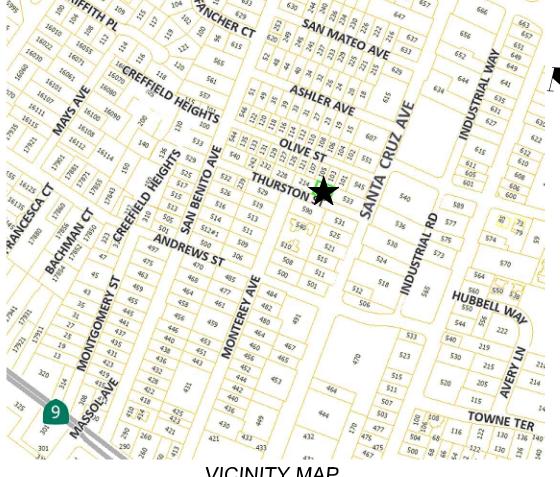



TABLE	OF PROPOSED PE	RVIOUS AND IMP	ERVIOUS AREA	<u>S</u>
TOTAL SITE AREA: 4,671± SF	TOTAL SITE AREA (INCLUDING CLEAF			
	EXISTING	PROPOSED	AREA (SF)	TOTAL AREA
	AREA (SF)	REPLACED	NEW	POST-PROJECT (SF)
IMPERVIOUS AREA	2,258	2,258	136	2,394
TOTAL NEW & REPLACED IN	MPERVIOUS AREA	2,3	394	
PERVIOUS AREA	2,413	2,277	0	2,277

TABLE OF PROPOSED EARTHWORK QUANTITIES						
AREA DESCRIPTION	CUT (CY)	MAX CUT HEIGHT (FT)	FILL (CY)	MAX FILL DEPTH (FT)	IMPORT/ EXPORT (CY)	
HOUSE FOOTPRINT	_	_	_	_	_	
BASEMENT	349.91	11.0	_	_	349.91	
ATTACHED GARAGE	_	_	_	_	_	
ACCESSORY BUILDING	_	_	_	_	_	
POOL	_	_	_	_	_	
DRIVEWAY/ACCESS	_	_	_	_	_	
LANDSCAPE/OUTDOOR	5.00	0.5	5.00	0.5	10.00	
TOTAL	354.91		5.00		359.91	


	LANDSCAPE/OUTDOOR	5.00	0.5	5.00	0.5	10.00
	TOTAL	354.91		5.00		359.91
			LEGENE	<u>)</u>		
	<u>EXISTING</u>		<u>PROPOSED</u>		TO BE RI	<u>EMOVED</u>
SIDEWALK		-	4 4 4	1 - 1 - 1 - 1 - 1 - 1 - 1 - 1 - 1 - 1 -		
CURB AND GUTTER		4.	4 4	4 4	=====	
CENTER LINE		. <u> </u>				
PROPERTY LINE	P				——————————————————————————————————————	
LOT LINE		•				
EASEMENT LINE		—				
EDGE OF PAVEMENT						
DRIVEWAY			4 44	4		
		44	- A	<u> </u>	a. 4.4	त्र इ.स.च्या
PCC	4 4 4 4 4 4 4		4 4 4 4 4 4	4		4 4
AC						
STANDARD MONUMENT						
BENCH MARK	\oplus		•		/ ^\	
MANHOLE					0	
SANITARY SEWER CLEANOUT					(6)	
SANITARY SEWER MANHOLE STORM DRAIN MANHOLE	<u>s</u>				(SS) (SD)	
STORM DRAIN INLET			SD			
WATER METER	WM		WM		[WM]	
VALVE	\bowtie		\bowtie			
FIRE HYDRANT	Q		A		R	
STREET LIGHT	—		\bigcirc		χ.	→
POWER POLE	-(P-		-P-		-(JP)-	
DOWNSPOUT WITH SPLASH BLOCKS					E=1	
CABLE TELEVISION LINE	TV		TV		TV	
ELECTRICAL LINE	—— E ——		— E —		E	
ELECTRICAL METER	EM		EM		[EM]	
IRRIGATION LINE	——————————————————————————————————————		— IR —		,,,,	
NATURAL GAS LINE	G		G		G	
OVERHEAD LINE SANITARY SEWER LINE	——————————————————————————————————————		— он —		OH	
	———— SS ————		— SS —		SS	
STORM DRAIN LINE	——————————————————————————————————————		— SD —		SD	
TELEPHONE LINE WATER LINE	T	. 	T			
	W		— W —			
TRAFFIC SIGNAL CONDUIT	——— TS ———		— TS —		TS	
LIGHTING CONDUIT			L		L	
ROADSIDE SIGN & SIGN CODE	▽ R1		▼ R1		- o- {	₹1
FENCE		- ×	× ×		$- \times - \times -$	*

CDANING AND DDAINAGE DI ANS	DATE:	06/29/23
	SCALE:	NTS
TTT I I I I I I I I I I I I I I I I I I	DESIGN:	PT
GENERAL NOTES, LEGEND & ABBREVIATIONS DRAWN:	DRAWN:	PT
SBADING BERMIT APPLICATION NO	CHECK:	NC
	ENGR:	NC
	PROJECT NO.:	•:



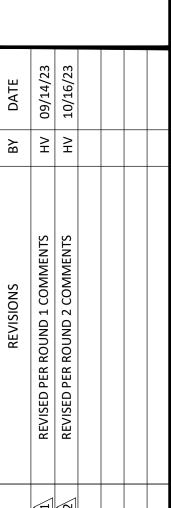

SHEET 1 OF 9

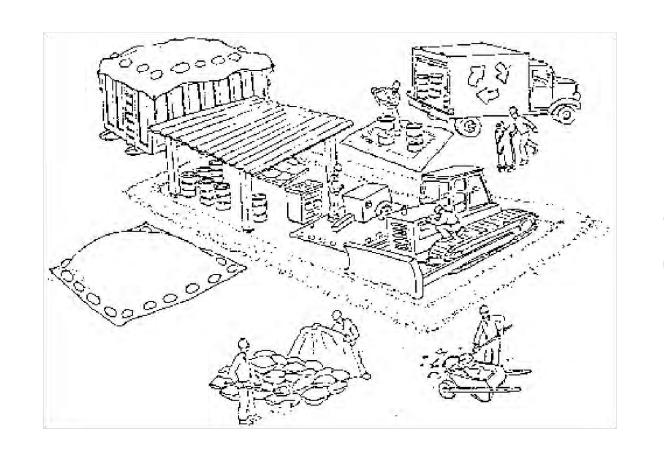

Make sure your crews and subs do the job right!

Runoff from streets and other paved areas is a major source of pollution in San Francisco Bay. Construction activities can directly affect the health of the Bay unless contractors and crews plan ahead to keep dirt, debris, and other construction waste away from storm drains and local creeks. Following these guidelines will ensure your compliance with local ordinance requirements.



Materials storage & spill cleanup

Non-hazardous materials management

- ✓ Sand, dirt, and similar materials must be stored at least 10 feet from catch basins, and covered with a tarp during wet weather or when rain is forecast.
- ✓ Use (but don't overuse) reclaimed water for dust control as needed.
- ✓ Sweep streets and other paved areas daily. Do not wash down streets or work areas with water!
- ✔ Recycle all asphalt, concrete, and aggregate base material from demolition activities.
- ✔ Check dumpsters regularly for leaks and to make sure they don't overflow. Repair or replace leaking dumpsters promptly.

Hazardous materials management

- ✓ Label all hazardous materials and hazardous wastes (such as pesticides, paints, thinners, solvents, fuel, oil, and antifreeze) in accordance with city, state, and federal regulations.
- ✓ Store hazardous materials and wastes in secondary containment and cover them during wet weather.
- ✓ Follow manufacturer's application instructions for hazardous materials and be careful not to use more than necessary. Do not apply chemicals outdoors when rain is forecast within 24 hours.
- ✔ Be sure to arrange for appropriate disposal of all hazardous wastes.

Spill prevention and control

Bay Area Stormwater Management

Agencies Association (BASMAA)

1-888-BAYWISE

- Keep a stockpile of spill cleanup materials (rags, absorbents, etc.) available at the construction site at all times.
- ✓ When spills or leaks occur, contain them immediately and be particularly careful to prevent leaks and spills from reaching the gutter, street, or storm drain. Never wash spilled material into a gutter, street, storm drain, or creek!
- ✓ Report any hazardous materials spills immediately! Dial 911 or your local emergency response number.

maintenance & cleaning ✓ Inspect vehicles and equipment for leaks frequently. Use drip pans to catch leaks until repairs are made; repair leaks

Vehicle and equipment

- ✓ Fuel and maintain vehicles on site only in a bermed area or over a drip pan that is big enough to prevent runoff.
- ✓ If you must clean vehicles or equipment on site, clean with water only in a bermed area that will not allow rinsewater to run into gutters, streets, storm drains, or creeks.
- ✓ Do not clean vehicles or equipment on-site using soaps, solvents, degreasers, steam cleaning equipment, etc.



Earthwork & contaminated soils

- ✓ Keep excavated soil on the site where it is least likely to collect in the street. Transfer to dump trucks should take place on the site, not in the street.
- Use hay bales, silt fences, or other control measures to minimize the flow of silt off the site.



- ✓ Avoid scheduling earth moving activities during the rainy season if possible. If grading activities during wet weather are allowed in your permit, be sure to implement all control measures necessary to prevent erosion.
- Mature vegetation is the best form of erosion control. Minimize disturbance to existing vegetation whenever possible.
- ✓ If you disturb a slope during construction, prevent erosion by securing the soil with erosion control fabric, or seed with fast-growing grasses as soon as possible. Place hay bales down-slope until soil is secure.
- ✓ If you suspect contamination (from site history, discoloration, odor, texture, abandoned underground tanks or pipes, or buried debris), call your local fire department for help in determining what testing should be done.
- ✓ Manage disposal of contaminated soil according to Fire Department instructions.

Dewatering operations

- ✓ Reuse water for dust control, irrigation, or another on-site purpose to the greatest extent possible.
- Be sure to call your city's storm drain inspector before discharging water to a street, gutter, or storm drain. Filtration or diversion through a basin, tank, or sediment trap may be required.
- ✓ In areas of known contamination, testing is required prior to reuse or discharge of groundwater. Consult with the city inspector to determine what testing to do and to interpret results. Contaminated groundwater must be treated or hauled off-site for proper disposal.

Saw cutting

- ✓ Always completely cover or barricade storm drain inlets when saw cutting. Use filter fabric, hay bales, sand bags, or fine gravel dams to keep slurry out of the storm drain system.
- ✓ Shovel, absorb, or vacuum saw-cut slurry and pick up all waste as soon as you are finished in one location or at the end of each work day (whichever is sooner!).
- ✓ If saw cut slurry enters a catch basin, clean it up immediately.

Paving/asphalt work



- ✓ Do not pave during wet weather or when rain is forecast.
- ✓ Always cover storm drain inlets and manholes when paving or applying seal coat, tack coat, slurry seal, or fog seal.
- ✔ Place drip pans or absorbent material under paving equipment when not in use.
- ✔ Protect gutters, ditches, and drainage courses with hay bales, sand bags, or earthen berms.
- ✓ Do not sweep or wash down excess sand from sand sealing into gutters, storm drains, or creeks. Collect sand and return it to the stockpile, or dispose of it as trash.
- ✓ Do not use water to wash down fresh asphalt concrete pavement.

Concrete, grout, and mortar storage & waste disposal

- ✔ Be sure to store concrete, grout, and mortar under cover and away from drainage areas. These materials must never reach a storm drain.
- ✓ Wash out concrete equipment/trucks off-site or designate an on-site area for washing where water will flow onto dirt or into a temporary pit in a dirt area. Let the water seep into the soil and dispose of hardened concrete with trash.



- ✓ Divert water from washing exposed aggregate concrete to a dirt area where it will not run into a gutter, street, or storm drain.
- ✓ If a suitable dirt area is not available, collect the wash water and remove it for appropriate disposal off site.

Painting

- Never rinse paint brushes or materials in a gutter or street!
- ✓ Paint out excess water-based paint before rinsing brushes, rollers, or containers in a sink. If you can't use a sink, direct wash water to a dirt area and spade it in.



- ✔ Paint out excess oil-based paint before cleaning brushes in thinner.
- ✓ Filter paint thinners and solvents for reuse whenever possible. Dispose of oil-based paint sludge and unusable thinner as hazardous waste.

Storm drain polluters may be liable for fines of up to \$10,000 per day!

SCALE: NTS
DESIGN: PT
DRAWN: PT
CHECK: NC
ENGR: NC

212 THURSTON STREET
BLUEPRINT FOR A CLEAR BAY
GRADING PERMIT APPLICATION NO.

17 8

LEERAIN598 E Santa Clara St, #270

San Jose, CA 95112

Phone: (408) 806-7187



ER ROUND 2 COMMENTS

HV 09/14/23


ER ROUND 2 COMMENTS

HV 10/16/23

REVISED PER ROUND 1 COMMENTS

REVISED PER ROUND 2 COMMENTS

SHEET 2 OF 9

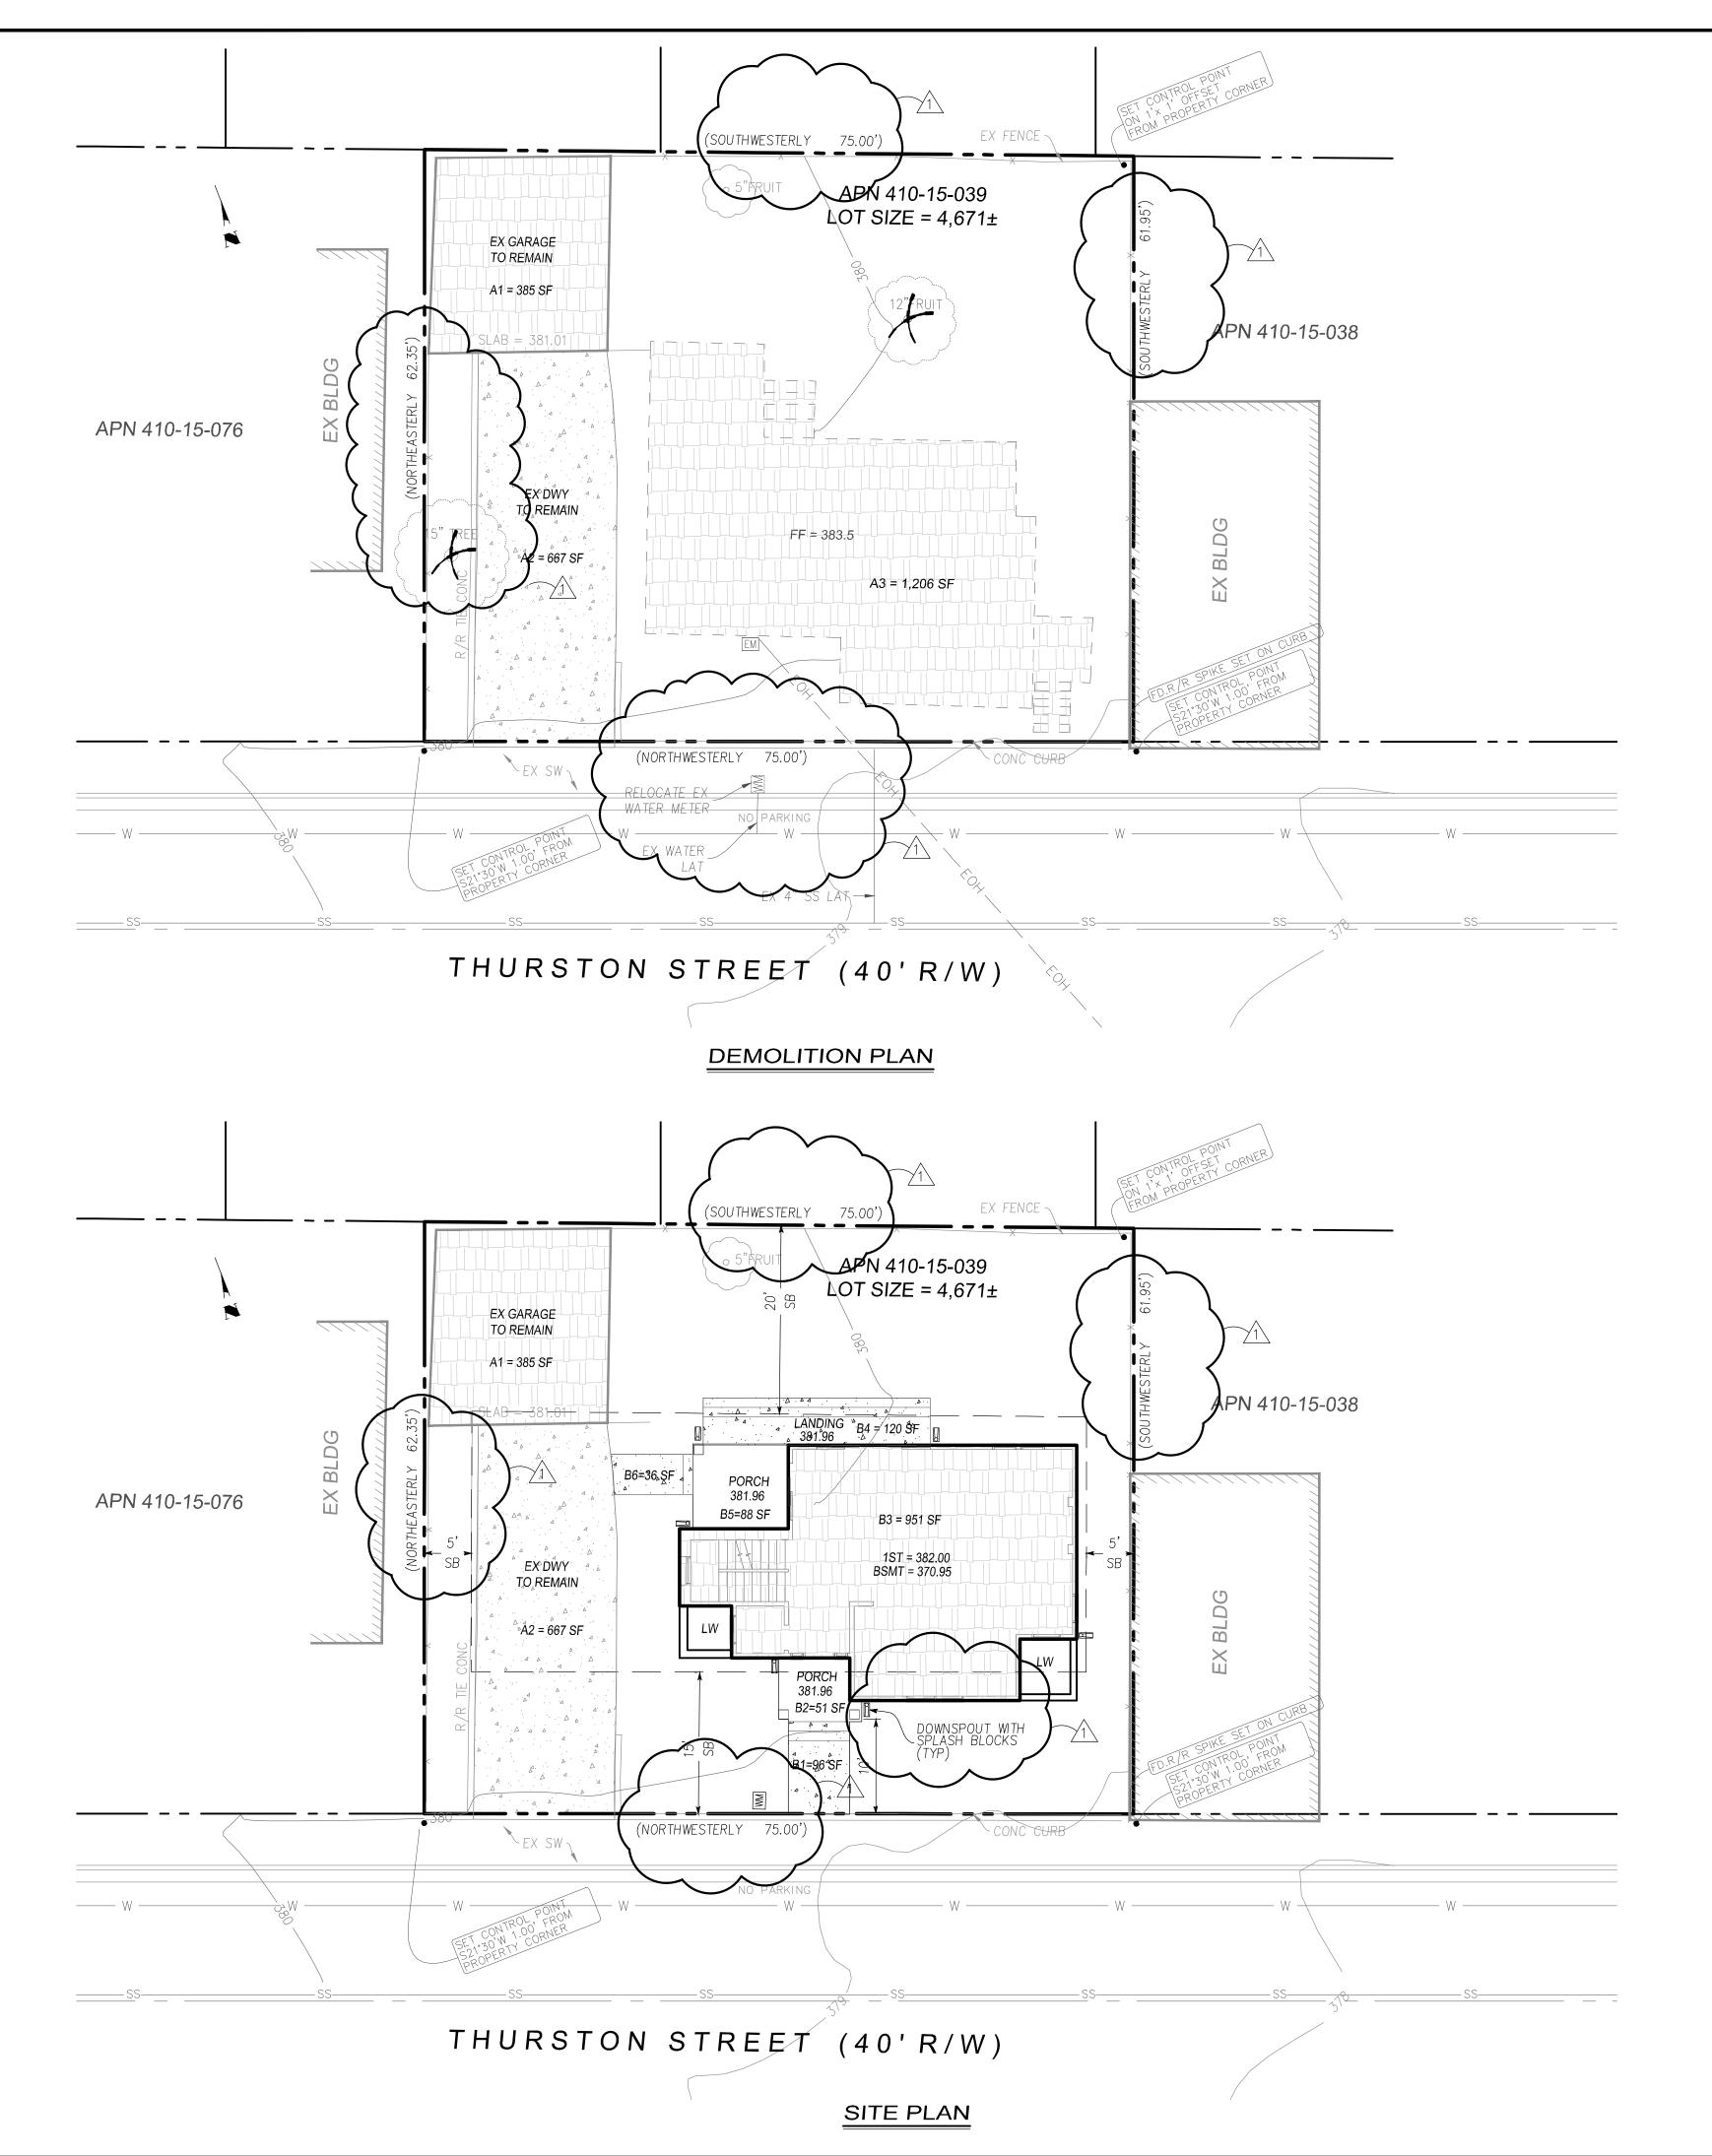

LEGEND

ITEM OR AREA TO BE REMOVED

ITEM OR AREA TO REMAIN

PROPOSED CONC

EX CONC TO REMAIN

EX BLDG TO REMAIN

BUILDING

7" EXISTING TREE TO REMAIN

{4

EXISTING TREE TO BE REMOVED

PRE-DEVELOPMENT

II EIVI#		DESCRIP	TION	IIVIPERVIOUS	PERVIOUS
	A1	GARAGE	(REMAIN)	385 SF	
	A2	DWY	(REMAIN)	667 SF	
	A3	BLDG	(REMOVE)	1,206 SF	
		LANDSCAPE			2,413 SF
		TOTAL		2,258 SF	2,413 SF

POST-DEVELOPMEN	V
-----------------	---

DESCRIP	TION	IMPERVIOUS	PERVIOUS
GARAGE	(REMAIN)	385 SF	
DWY	(REMAIN)	667 SF	
WLK	(NEW)	96 SF	
PORCH	(NEW)	51 SF	
BLDG	(NEW)	951 SF	
LANDING	(NEW)	120 SF	
PORCH	(NEW)	88 SF	
WLK	(NEW)	36 SF	
LANDSCAPE			2,277 SF
TOTAL		2,394 SF	2,277 SF
	GARAGE DWY WLK PORCH BLDG LANDING PORCH WLK LANDSCAPE	DWY (REMAIN) WLK (NEW) PORCH (NEW) BLDG (NEW) LANDING (NEW) PORCH (NEW) WLK (NEW) LANDSCAPE (NEW)	GARAGE (REMAIN) 385 SF DWY (REMAIN) 667 SF WLK (NEW) 96 SF PORCH (NEW) 51 SF BLDG (NEW) 951 SF LANDING (NEW) 120 SF PORCH (NEW) 88 SF WLK (NEW) 36 SF LANDSCAPE (NEW) 36 SF

SUMMARY


ITEM#	DESCRIPTION	IMPERVIOUS	PERVIOUS
1	PRE-DEVELOPMENT	2,258 SF	2,413 SF
2	POST-DEVELOPMENT	2,394 SF	2,277 SF
	TOTAL	136 SF	-136 SF

BASIS OF ELEVATIONS

ELEVATIONS SHOWN ON THIS MAP ARE BASED ON THE TOWN OF LOS GATOS BENCHMARK "LG 31". ELEVATION =367.04', NGVD 29

BASIS OF BEARINGS

THE BEARINGS SHOWN ON THIS MAP ARE BASED ON AVERAGING CURB LINES ALONG THURSTON STREET AND HOLDING THE BEARING OF N68°30'W AS SHOWN ON THE MAP OF THE NOTT SUBDIVISION FILED IN BOOK"D" OF MAPS,PAGE 9,SANTA CLARA COUNTY RECORDS.

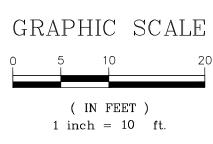

No. 47518

No. 47518

AT

No. A7518

No. A7518

No. A7518

No. A7518

No. A7518

No. A7518

SCALE: NTS
DESIGN: PT
DRAWN: PT
CHECK: NC
ENGR: NC

PLAN


GRADING AND DRAINAGE PLANS
212 THURSTON STREET
DEMOLITION PLAN & SITE PLAN


598 E Santa Clara St. #270 San Jose, CA 95112 Phone: (408) 806-7187





REVISIONS BY DATE
REVISED PER ROUND 1 COMMENTS HV 09/14/23
REVISED PER ROUND 2 COMMENTS HV 10/16/23

SHEET 3 OF 9

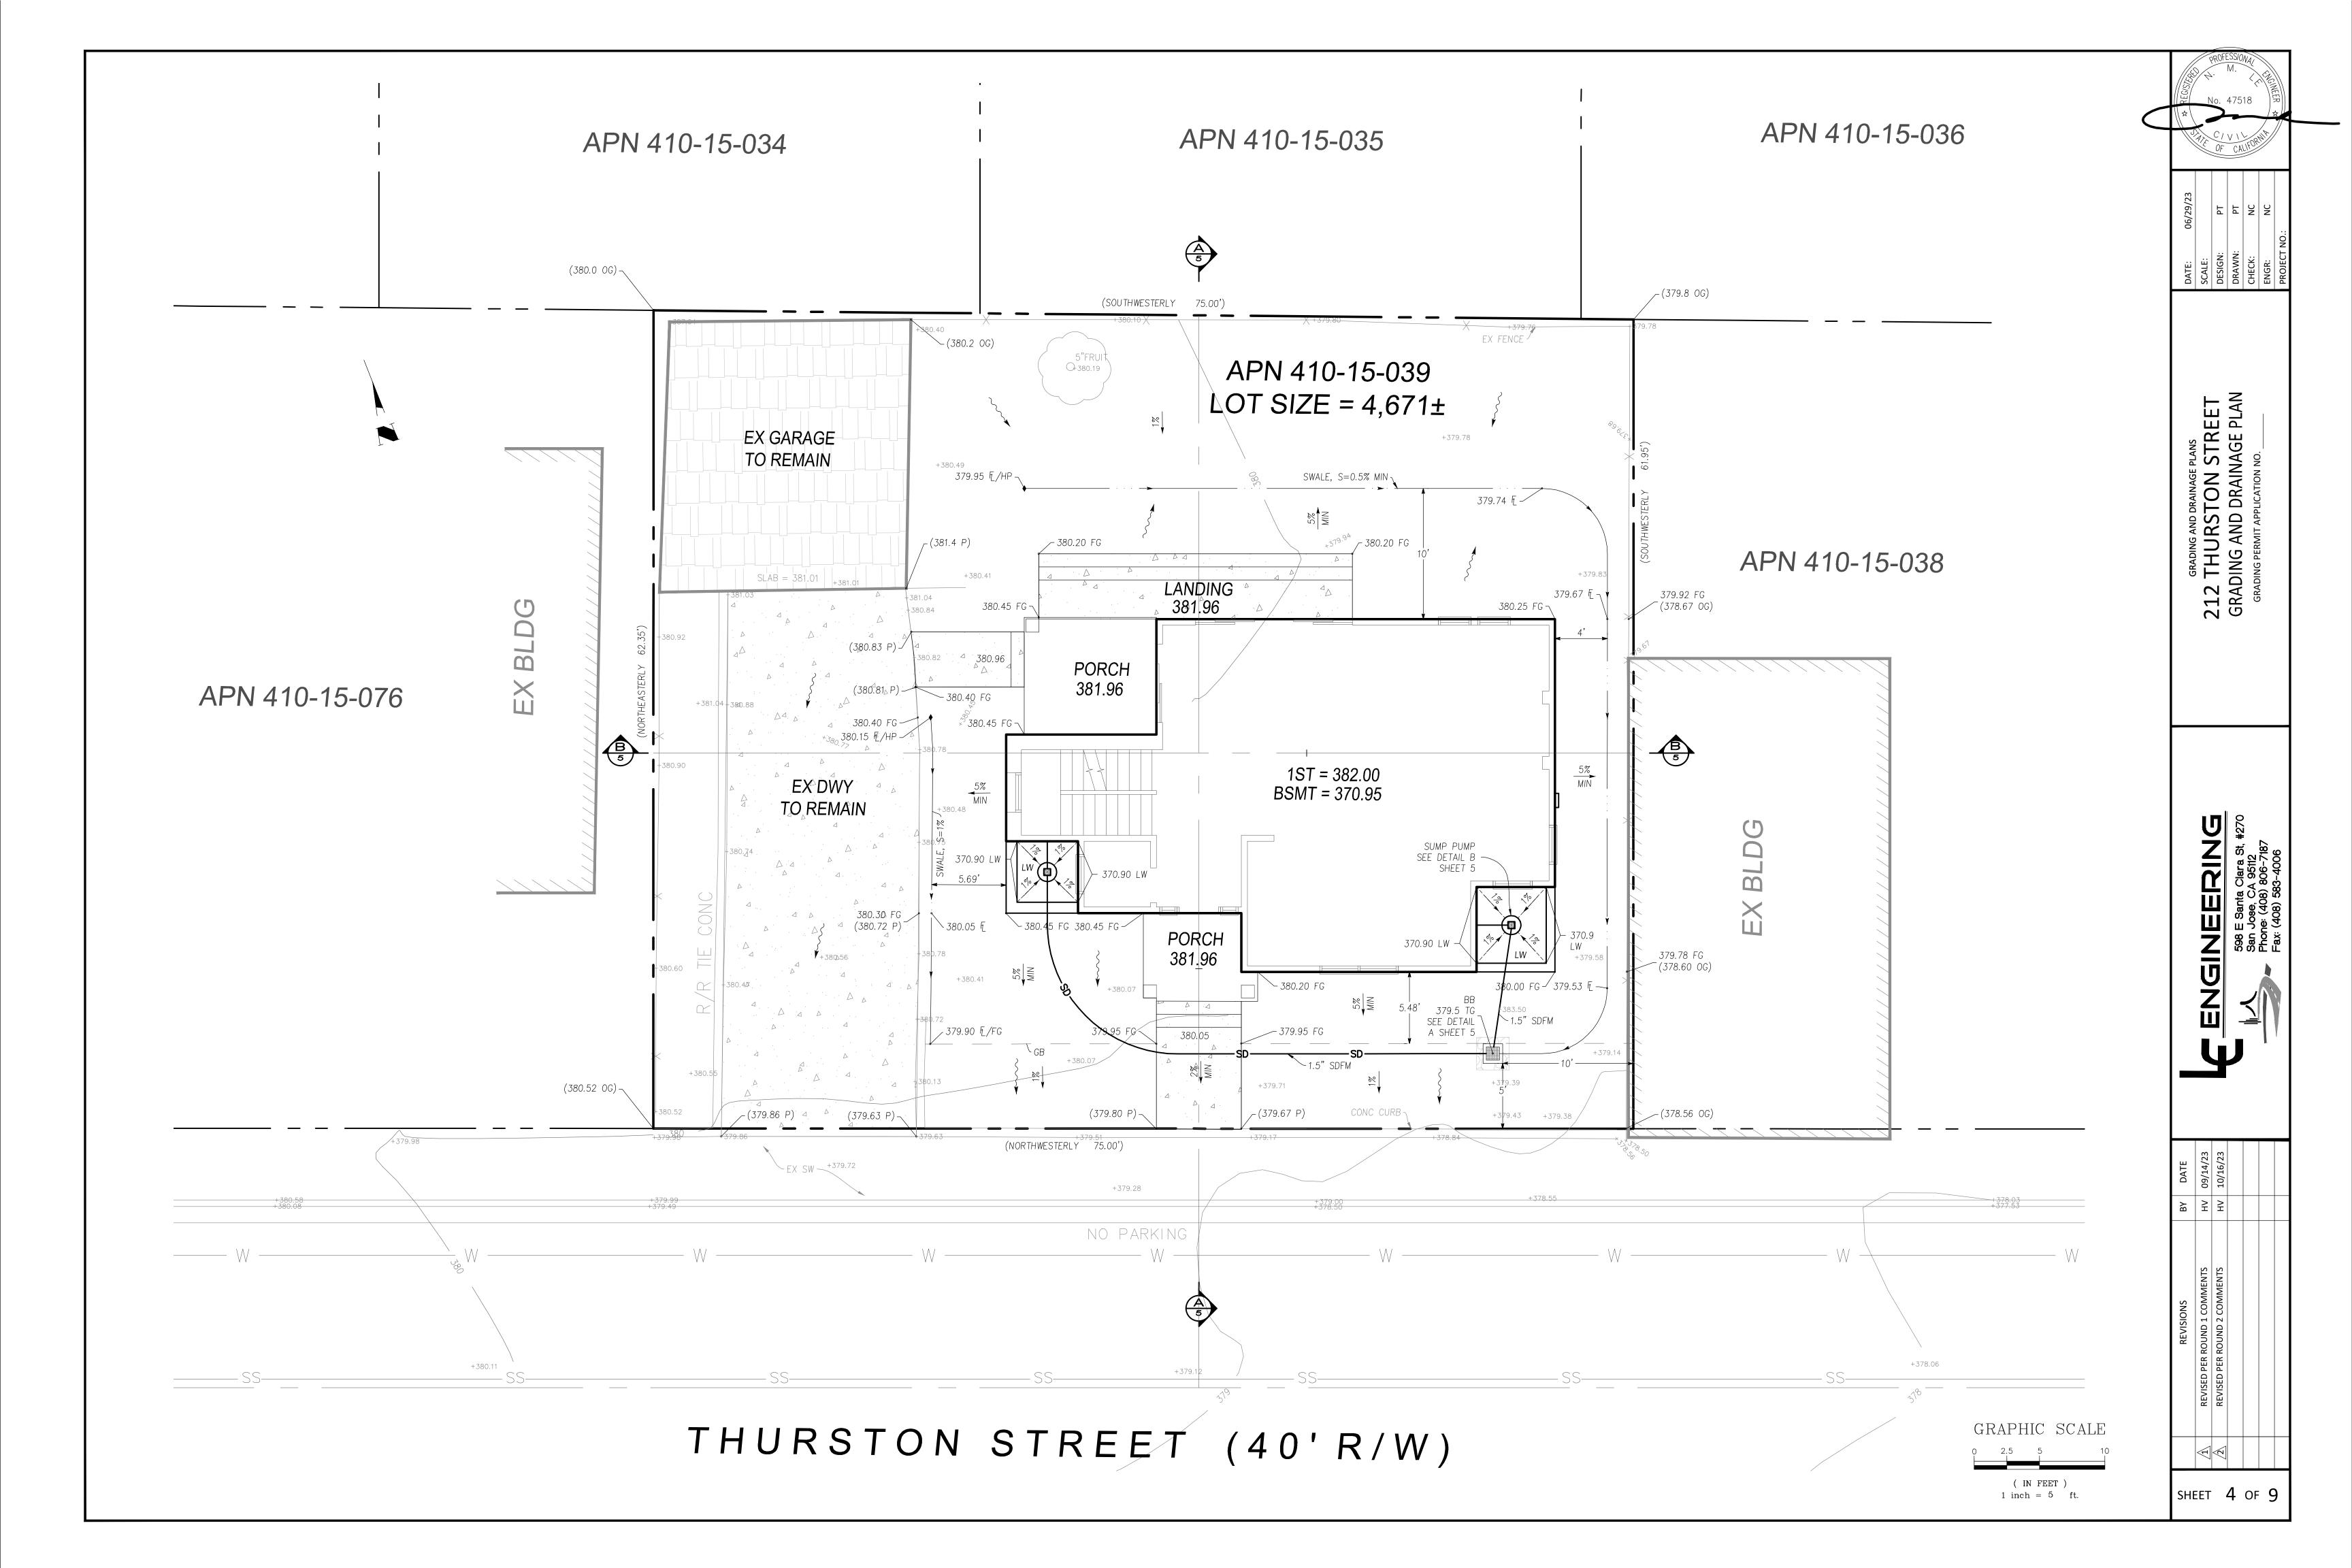


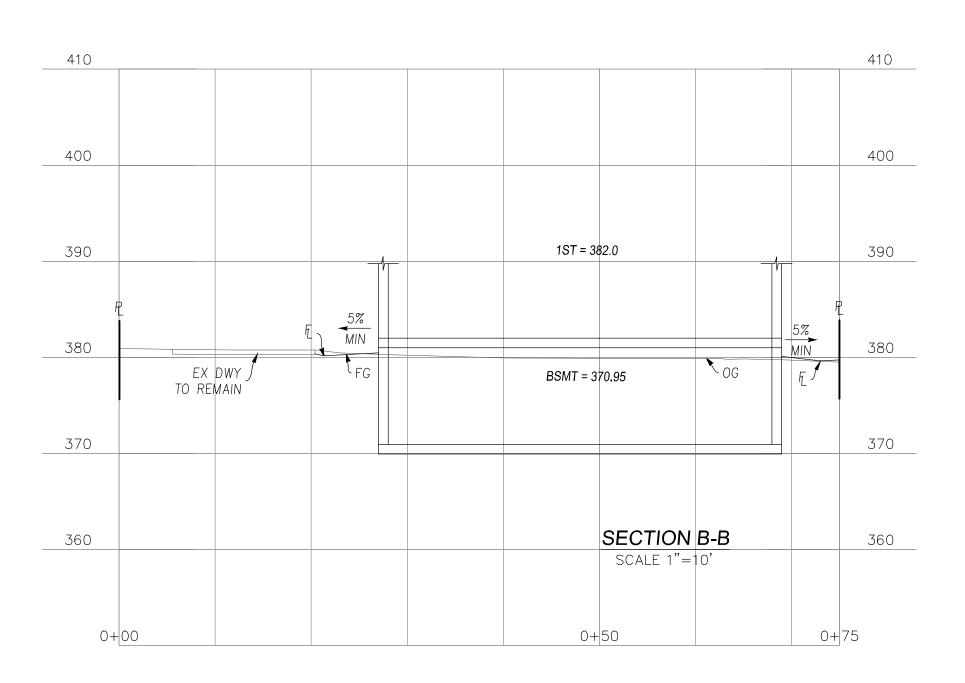

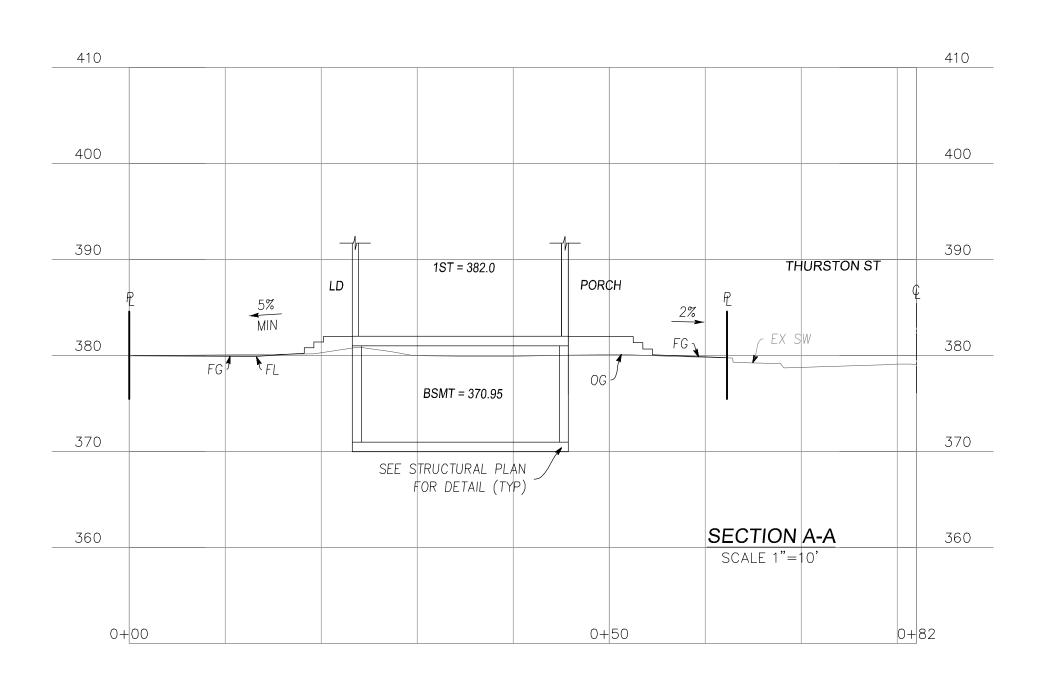

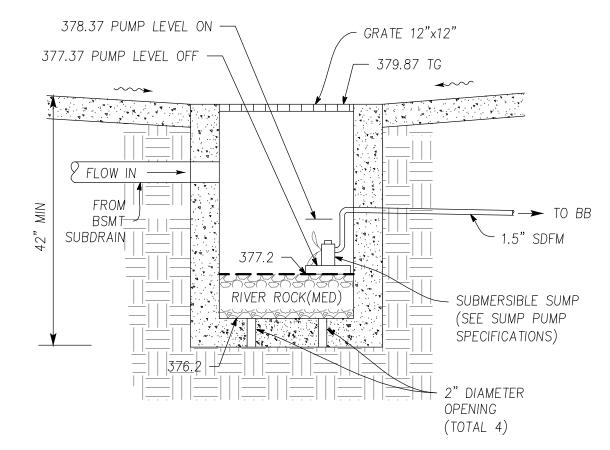


DETAIL B - SUMP PUMP STATION

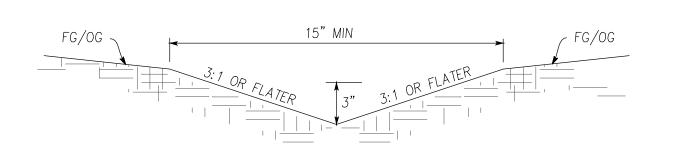

SWALE TYPICAL SECTION


NTS

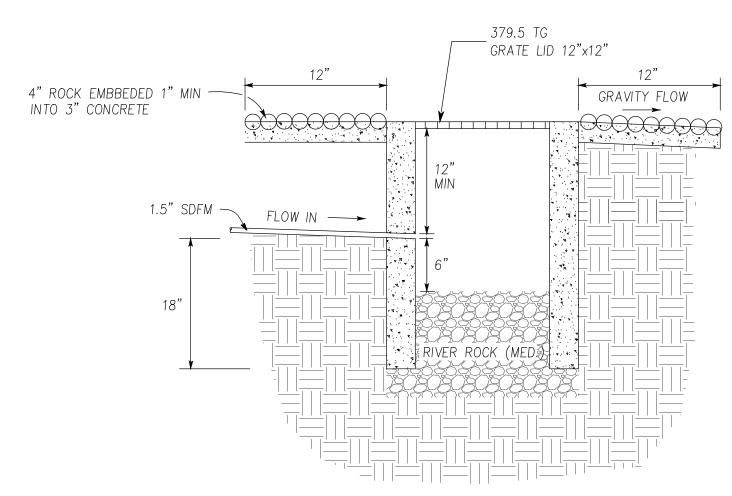

DETAIL A - BUBBLER BOX

NOTES:

- 1. RIGID PLASTIC, A.C., C.I., OR STEEL PIPE ALLOWED TO BOX FROM INLET
- 2. BOX SHALL BE SET WITH ADJACENT GRADES SLOPING AWAY TO PREVENT RAINWATER & LANDSCAPE WATER FROM ENTERING.
- 3. BOX SHALL BE SET IN LANDSCAPED AREA TO FACILITATE PERCOLATION.
- 4. BOX SHALL NOT HAVE CONCRETE BOTTOM TO FACILITATE PERCOLATION.

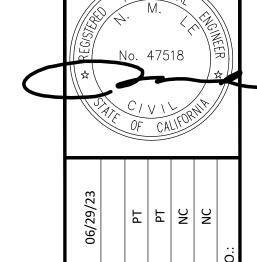

V STREET
SECTIONS

GRADING AND DRAINAGE PLANS

212 THURSTON STREET

BUILDING CROSS SECTIONS

GRADING PERMIT APPLICATION NO.

598 E Santa Clara St, #270 San Jose, CA 95112 Phone: (408) 806-7187 Fax: (408) 583-4006



BY DATE	HV 09/14/23	HV 10/16/23		
REVISIONS	REVISED PER ROUND 1 COMMENTS	REVISED PER ROUND 2 COMMENTS		

1 inch = 10 ft.





21

APN 410-15-036

APN 410-15-038

UNDERGROUND EX ELEC. LINE

APN 410-15-035

APN 410-15-039 LOT SIZE = 4,671±

1ST = 382.00 BSMT = 370.95

___CONNECT = BSMT SS

— 1.5" SSFM

CONNECT TO NEW SSCO

CONNECT TO EX

CONNECT ELEC. _ TO EX JP

(SOUTHWESTERLY 75.00')

LANDING * 381.96

PORCH 381.96

INSTALL NEW
WATER METER
PER CSD WA-501

CONNECT TO _/ EX WATER LAT

(NORTHWESTERLY 75.00')

THURSTON STREET (40'R/W)

EX FENCE \

APN 410-15-034

APN 410-15-076

EX GARAGE TO REMAIN

EX DWY
TO REMAIN

EX SW

SHEET 6 OF 9

GRAPHIC SCALE

(IN FEET) 1 inch = 10 ft.


REV.: SEPT. 2016

GRADING AND DRAINAGE PLANS

12 THURSTON STREET

EROSION CONTROL PLAN

SHEET 7 OF 9

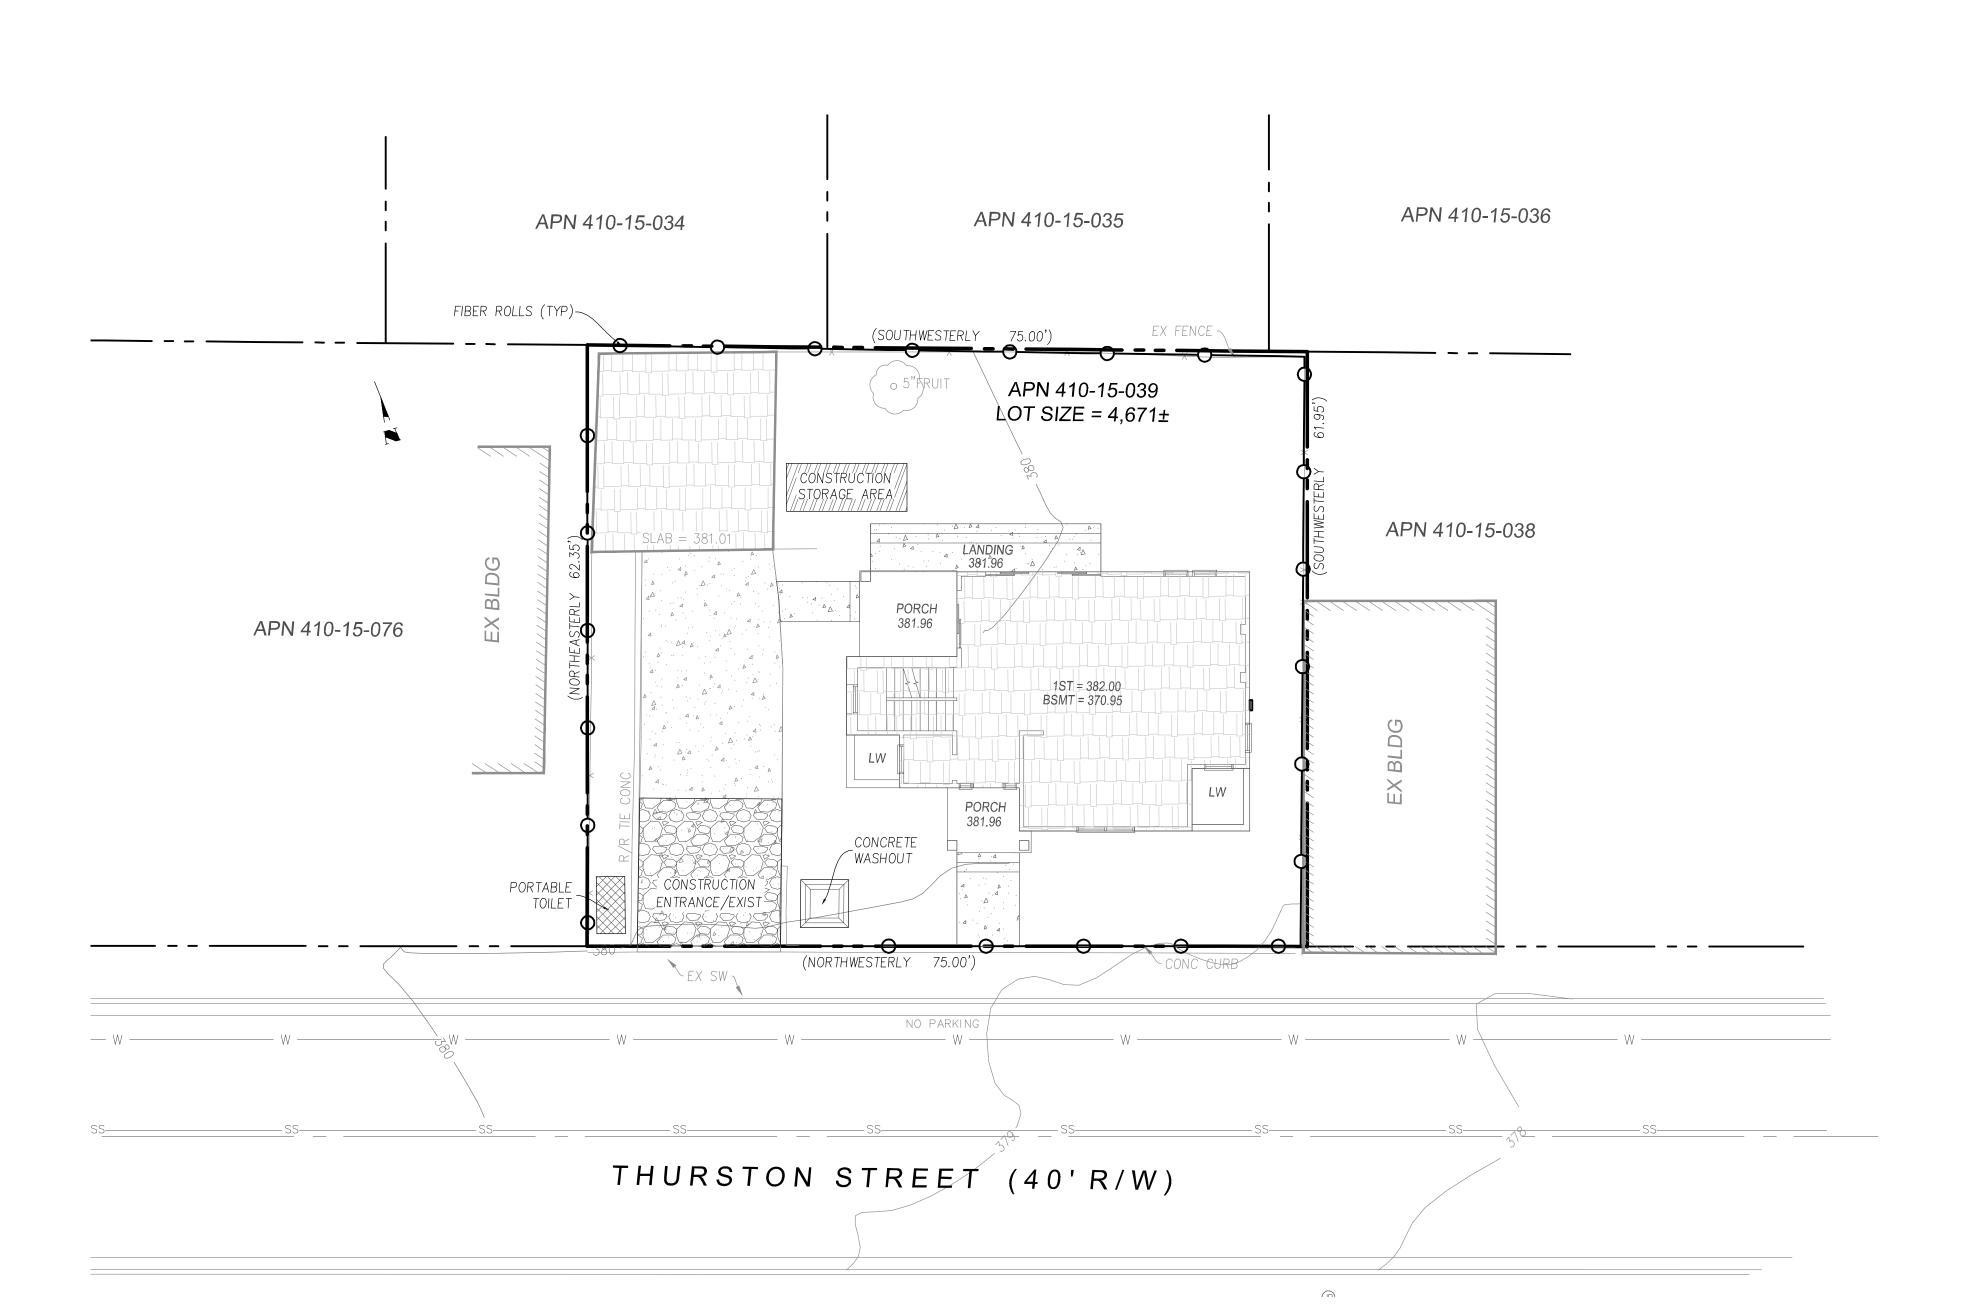

- 1. EROSION AND SEDIMENTS CONTROL SHALL REMAIN IN PLACE AND MAINTAINED UNTIL THE PERMANACT LANDSCAPING IS INSTALLED.
- 2. CONTRACTOR TO PROVIDE STORMDRAIN INLET PROTECTION AT NEAREST INLET DOWNSTREAM OF PROJECT SITE

LEGEND




CONSTRUCTION / STORAGE AREA CONSTRUCTION STORAGE AREA

— FIBER ROLLS

PORTABLE TOILET

TEMPORARY GRAVEL CONSTRUCTION ENTRANCE/EXIST

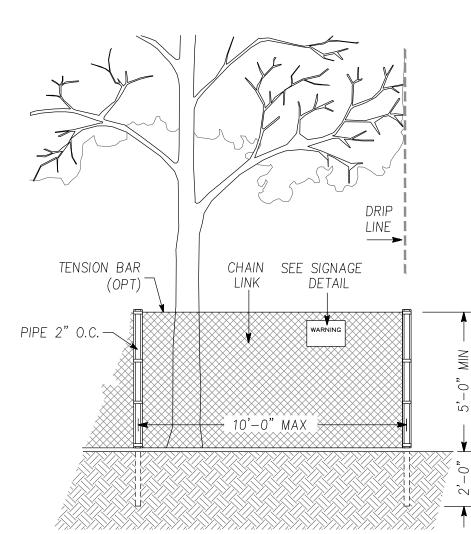

EXISTING TREE PROTECTION DETAIL

- 1. PRIOR TO THE COMMENCEMENT OF ANY GRADING, TREE PROTECTIVE FENCING SHALL BE IN PLACE IN ACCORDANCE WITH THE TREE PRESERVATION PLAN AND INSPECTED BY A CERTIFIED ARBORIST. THE ARBORIST SHALL MONITOR CONSTRUCTION ACTIVITY TO ENSURE THAT THE TREE PROTECTION MEASURES ARE IMPLEMENTED AND ADHERED TO DURING CONSTRUCTION. THIS CONDITION SHALL BE INCORPORATED INTO THE GRADING PLANS.
- 2. FENCE SHALL BE MINIMUM 5 FEET TALL CONSTRUCTED OF STURDY MATERIAL (CHAIN-LINK OR EQUIVALENT STRENGTH/ DURABILITY).
- 3. FENCE SHALL BE SUPPORTED BY VERTICAL POSTS DRIVEN 2 FEET (MIN) INTO THE GROUND AND SPACED NOT MORE THAN 10 FEET APART.
- 4. TREE FENCING SHALL BE MAINTAINED THROUGHOUT THE SITE DURING THE CONSTRUCTION PERIOD, INSPECTED PERIODICALLY FOR DAMAGE AND PROPER FUNCTION, REPAIRED AS NECESSARY TO PROVIDE A PHYSICAL BARRIER FROM CONSTRUCTION ACTIVITIES, AND REMAIN IN PLACE UNTIL THE FINAL INSPECTION.
- 5. A SIGN THAT INCLUDES THE WORDS, "WARNING: THIS FENCE SHALL NOT BE REMOVED WITHOUT THE EXPRESSED PERMISSION OF THE CITY LOS GATOS PLANNING OFFICE," SHALL BE SECURELY ATTACHED TO THE FENCE IN A VISUALLY PROMINENT LOCATION.

GENERAL EROSION AND SEDIMENT CONTROL NOTES:

1. CONTRACTOR/OWNER: MELEAH GUILLARDO

ADDRESS: 212 THURSTON STREET, LOS GATOS, CA 95030

PHONE NUMBER:

IT SHALL BE THE OWNER'S RESPONSIBILITY TO MAINTAIN CONTROL OF THE ENTIRE CONSTRUCTION OPERATION AND TO KEEP THE ENTIRE SITE IN COMPLIANCE WITH THE SOIL EROSION CONTROL PLAN.

2. CIVIL ENGINEER: LC ENGINEERING 598 E SANTA CLARA ST, SUITE #270,

SAN JOSE, CA 95112.

(408) 806-7187 3. CONTRACTOR: MELEAH GUILLARDO

ADDRESS: 212 THURSTON STREET, LOS GATOS, CA 95030

24-HOUR PHONE NUMBER:

CONSTRUCTION SUPERINTENDENT: MELEAH GUILLARDO

ADDRESS:

212 THURSTON STREET, LOS GATOS, CA 95030

24-HOUR PHONE NUMBER:

- 4. THIS PLAN IS INTENDED TO BE USED FOR INTERIM EROSION AND SEDIMENT CONTROL ONLY AND IS NOT TO BE USED FOR FINAL ELEVATIONS OR PERMANENT IMPROVEMENTS.
- 5. DEVELOPER WILL SUBMIT TO THE COUNTY/CITY MONTHLY (AT THE FIRST OF EACH MONTH BETWEEN OCT 15TH AND APRIL 15TH) CERTIFICATIONS THAT ALL EROSION/SEDIMENT MEASURES IDENTIFIED ON THE APPROVED EROSION CONTROL PLAN ARE IN PLACE. IF MEASURES ARE NOT IN PLACE, DEVELOPER SHALL PROVIDE THE COUNTY/CITY WITH A WRITTEN EXPLANATION OF WHY THE MEASURE IS NOT IN PLACE AND WHAT WILL BE DONE TO REMEDY THIS SITUATION.
- 6. OWNER/CONTRACTER SHALL BE RESPONSIBLE FOR MONITORING EROSION AND SEDIMENT CONTROL MEASURES PRIOR, DURING, AND AFTER STORM EVENTS.
- 7. REASONABLE CARE SHALL BE TAKEN WHEN HAULING ANY EARTH, SAND, GRAVEL, STONE, DEBRIS, PAPER OR ANY OTHER SUBSTANCE OVER ANY PUBLIC STREET, ALLEY, OR OTHER PUBLIC PLACE. SHOULD ANY BLOW, SPILL, OR TRACK OVER AND UPON SAID PUBLIC OR ADJACENT PRIVATE PROPERTY, IMMEDIATE REMEDY SHALL OCCUR.
- 8. SANITARY FACILITIES SHALL BE MAINTAINED ON THE SITE.
- 9. DURING THE RAINY SEASON, ALL PAVED AREAS SHALL BE KEPT CLEAR OF EARTH MATERIAL AND DEBRIS. THE SITE SHALL BE MAINTAINED SO AS TO MINIMIZE SEDIMENT LADEN RUNOFF TO ANY STORM DRAINAGE SYSTEM, INCLUDING EXISTING DRAINAGE SWALES AND WATER COURSES.
- 10. CONSTRUCTION OPERATIONS SHALL BE CARRIED OUT IN SUCH A MANNER THAT EROSION AND WATER POLLUTION WILL BE MINIMIZED. STATE AND LOCAL LAWS CONCERNING POLLUTION ABATEMENT SHALL BE COMPILED WITH.
- 11. CONTRACTOR SHALL PROVIDE DUST CONTROL AS REQUIRED BY THE APPROPRIATE FEDERAL, STATE AND LOCAL AGENCY REQUIREMENTS.


EROSION AND SEDIMENT CONTROL MEASURES

- 1. THE FACILITIES SHOWN ON THIS PLAN ARE DESIGNED TO CONTROL EROSION AND SEDIMENT DURING THE RAINY SEASON, OCTOBER 15 TO APRIL 15. FACILITIES ARE TO BE OPERABLE PRIOR TO OCTOBER 1 OF ANY YEAR. GRADING OPERATIONS DURING THE RAINY SEASON WHICH LEAVE DENUDED SLOPES SHALL BE PROTECTED WITH EROSION CONTROL MEASURES IMMEDIATELY FOLLOWING GRADING ON THE SLOPES.
- 2. THIS PLAN COVERS ONLY THE FIRST WINTER FOLLOWING GRADING WITH ASSUMED SITE CONDITIONS AS SHOWN ON THE EROSION CONTROL PLAN. PRIOR TO SEPTEMBER 15, THE COMPLETION OF SITE IMPROVEMENT SHALL BE EVALUATED AND REVISIONS MADE TO THIS PLAN ARE NECESSARY WITH THE APPROVAL OF THE COUNTY/CITY ENGINEER. PLANS RESUBMITTED FOR THE COUNTY/CITY APPROVAL PRIOR TO SEPTEMBER 1 OF EACH SUBSEQUENT YEAR UNTIL ARE TO BESITE IMPROVEMENTS ARE ACCEPTED BY THE COUNTY/CITY.
- 3. CONSTRUCTION ENTRANCES SHALL BE INSTALL PRIOR TO COMMENCEMENT OF GRADING. ALL CONSTRUCTION TRAFFIC ENTERING ONTO THE PAVED ROADS MUST CROSS THE STABILIZED CONSTRUCTION ENTRANCE WAYS.
- 4. CONTRACTOR SHALL MAINTAIN STABILIZED ENTRANCE AT EACH VEHICLE ACCESS POINT TO EXISTING PAVED STREETS. ANY MUD OR DEBRIS TRACKED ON TO PUBLIC STREETS SHALL BE REMOVED DAILY AND AS REQUIRED BY THE COUNTY/CITY.
- 5. IF HYDROSEEDING IS NOT USED OR IS NOT EFFECTIVE BY 10/10, THEN OTHER IMMEDIATE METHODS SHALL BE IMPLEMENTED. SUCH AS EROSION CONTROL BLANKETS OR THREE-STEP APPLICATIONS OF 1) SEED, MULCH, FERTILIZER 2) BLOWN STRAW 3) TRICKIFIER AND MULCH.
- 6. INLET PROTECTION SHALL BE INSTALLED AT OPEN INLETS TO PREVENT SEDIMENT FROM ENTERING THE STORM DRAIN SYSTEM. INLETS NOT USED IN CONJUNCTION WITH EROSION CONTROL ARE TO BE BLOCKED TO PREVENT ENTRY OF
- 7. LOTS WITH HOUSES UNDER CONSTRUCTION WILL NOT BE HYDROSEEDED. EROSION PROTECTION FOR EACH LOT WITH A HOUSE UNDER CONSTRUCTION SHALL CONFORM TO THE TYPICAL LOT EROSION CONTROL DETAIL SHOWN ON THIS SHEET.
- 8. THIS EROSION AND SEDIMENT CONTROL PLAN MAY NOT COVER ALL THE SITUATIONS THAT MAY ARISE DURING CONSTRUCTION DUE TO UNANTICIPATED FIELD CONDITION. VARIATIONS AND ADDITIONS MAY BE MADE TO THIS PLAN IN THE FIELD. NOTIFY THE REPRESENTATIVE OF ANY FIELD CHANGES.
- 9. GRADING WORK BETWEEN OCTOBER 15 AND APRIL 15 IS AT THE DISCRETION OF COUNTY/CITY.


MAINTENANCE NOTES

- 1. MAINTENANCE IS TO BE PERFORMED AS FOLLOWS:
 - A. REPAIR DAMAGES CAUSED BY SOIL EROSION OR CONSTRUCTION AT THE END OF EACH WORKING DAY
 - B. SWALES SHALL BE INSPECTED PERIODICALLY AND MAINTAINED AS NEEDED.
- C. SEDIMENT TRAPS, BERMS, AND SWALES ARE TO BE INSPECTED AFTER EACH STORM AND REPAIRS MADE AS NEEDED. D. SEDIMENT SHALL BE REMOVED AND SEDIMENT TRAP RESTORED TO ITS ORIGINAL DIMENSIONS WHEN SEDIMENT HAS ACCUMULATED TO A DEPTH OF 1 FOOT.
- E. SEDIMENT REMOVED FROM TRAP SHALL BE DEPOSITED IN A SUITABLE AREA AND IN SUCH A MANNER THAT IT WILL NOT ERODE.
- F. RILLS AND FULLIES MUST BE REPAIRED.
- 2. SAND BAD INLET PROTECTION SHALL BE CLEANED OUT WHENEVER SEDIMENT DEPTH IS ONE HALF THE HEIGHT OF ONE SAND
- 3. EXPOSED SLOPE SHALL BE PROTECTED WITH JUTE NET AND/OR HYDROSEED. HYDROSEED SHALL BE A HOMOGENEOUSLY MIX OF SLURRY CONTAINING NOT LESS THAN 44 LBS OF ORGANIC MULCHING AMENDMENT PLUS FERTILIZER, CHEMICAL ADDITIVES AND SOLIDS FOR EACH 100 GALLONS OF WATER.


Fiber Rolls CASQA Detail SE-5

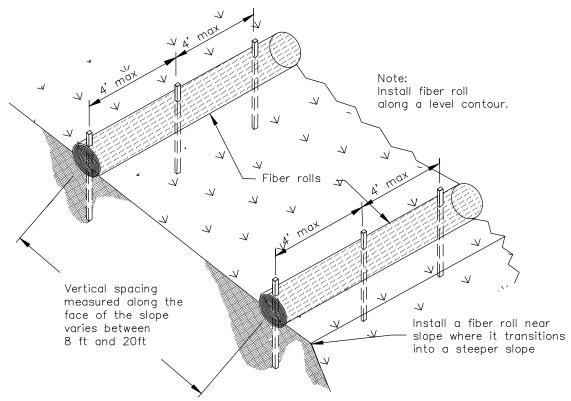


TYPICAL FIBER ROLL INSTALLATION

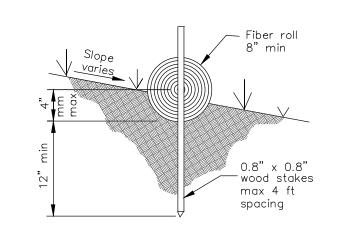

ENTRENCHMENT DETAIL

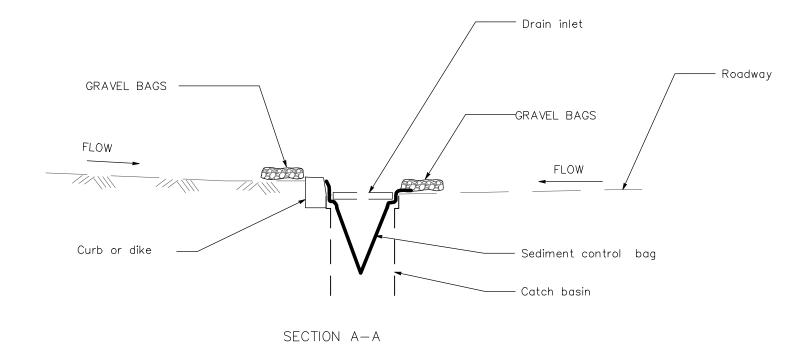


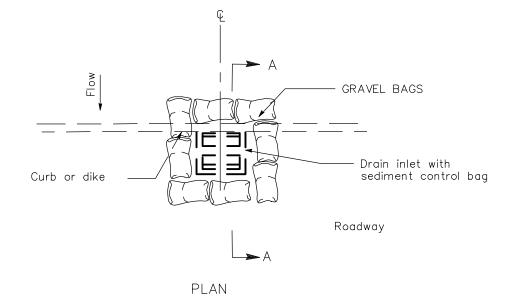


TEMPORARY DRAINAGE INLET PROTECTION

For paved areas exposed to traffic



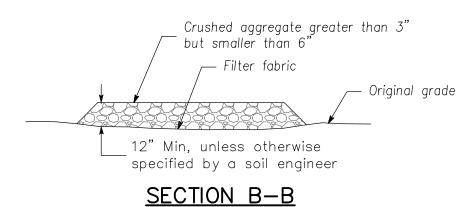


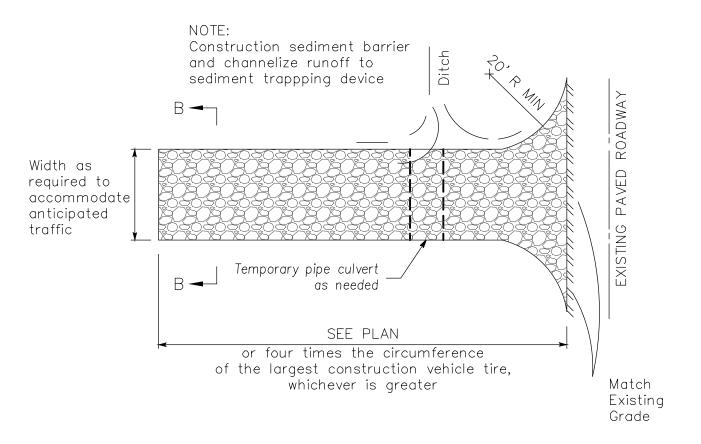



STREET DETAILS STON SONTROL GRADING, THUI OSION 7




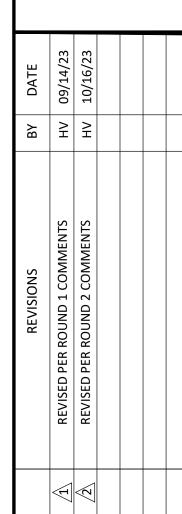

(NORTHWESTERLY 75.00')

THURSTON STREET (40'R/W)

NO PARKING

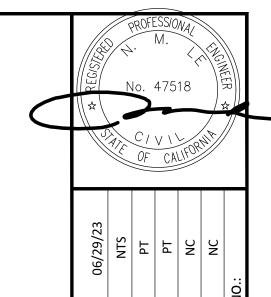

GRADING AND DRAINAGE PLANS

212 THURSTON STREET

CONSTRUCTION MANAGERMENT PLAN

GRADING PERMIT APPLICATION NO.



CONSTRUCTION SITE FIRE SAFETY:

ALL CONSTRUCTION SITES MUST COMPLY WITH APPLICABLE PROVISIONS OF THE CFC CHAPTER 33 AND OUR STANDARD DETAILS AND SPECIFICATION S1-7.

GRAPHIC SCALE (IN FEET) 1 inch = 10 ft. SHEET 9 OF 9 This Page Intentionally Left Blank